
# PROPOSED NEW HOUSE FOR MCKENZIE

# 53 MCCROSSIN AVENUE, BIRRONG NSW 2143

	CONSTRUCTION DRAWING SCHEDULE			
No	DRAWING NAME	ISSUE		
CD01	COVER SHEET	D		
CD02	GENERAL NOTES	D		
CD03	SITE ANALYSIS PLAN/EXISTING PLAN	D		
CD04	DEMOLITION PLAN - PROPOSED	D		
CD05	AREA PLAN - PROPOSED	D		
CD06	SITE PLAN - PROPOSED	D		
CD07	LANDSCAPE PLAN - PROPOSED	D		
CD08	FLOOR PLAN - PROPOSED	D		
CD09	SLAB SETOUT PLAN	D		
CD10	ROOF PLAN	D		
CD11	SERVICES PLAN	D		
CD12	ELECTRICAL PLAN	D		
CD13	ELEVATIONS - PROPOSED	D		
CD14	ELEVATIONS - PROPOSED	D		
CD15	SECTIONS	D		
CD16	CONSTRUCTION DETAILS 1	D		
CD17	CONSTRUCTION DETAILS 2	D		
CD18	LIGHTWEIGHT CLADDING CONSTRUCTION DETAILS	D		
CD19	WINDOW AND DOOR SCHEDULE	D		
CD20	GRANNY FLAT - PROPOSED	D		
CD21	GRANNY FLAT - PROPOSED ELEVATIONS 1	D		
CD22	GRANNY FLAT - PROPOSED ELEVATIONS 2	D		
CD23	SHADOW DIAGRAM - WINTER 21ST OF JUNE 8AM	D		
CD24	SHADOW DIAGRAM - WINTER 21ST OF JUNE 12PM	С		
CD25	SHADOW DIAGRAM - WINTER 21ST OF JUNE 4PM	D		
CD26	SHADOW DIAGRAM - SUMMER 21ST OF DECEMBER 8AM	D		
CD27	SHADOW DIAGRAM - SUMMER 21ST OF DECEMBER 12PM	D		
CD28	SHADOW DIAGRAM - SUMMER 21ST OF DECEMBER 4PM	D		
CD29	COLOUR AND FINISHES SCHEDULE	D		
CD30	FRONT STREETSCAPE - No.53	D		
CD31	SURVEY - NWS REF(24195) DATED-11 05 24	D		

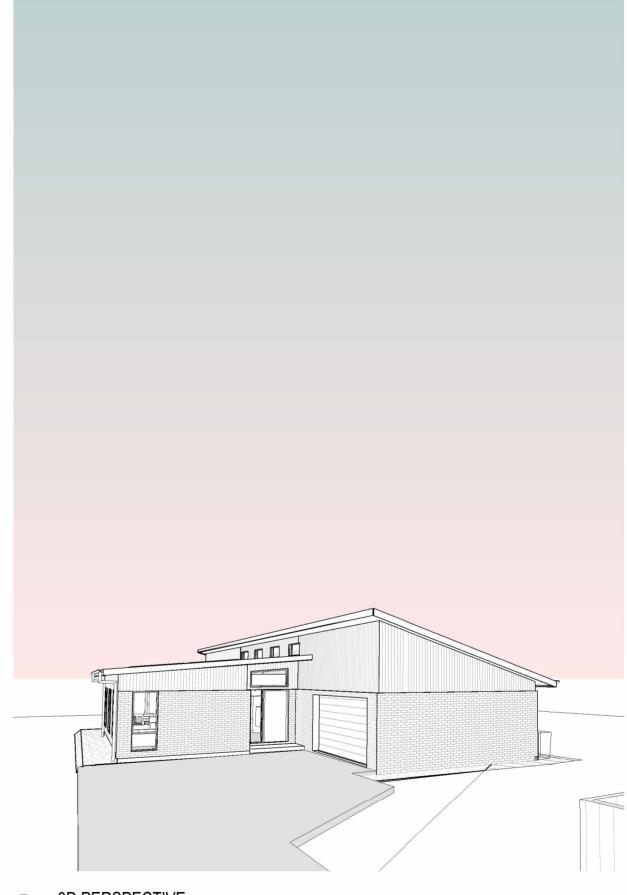

https://www.fr5.com.au/QRCodeLanding?PublicId=42MXX6VEXT





# **FLOOD AFFECTED**

CONSTRUCTION DRAWINGS





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REV	DATE	DESCRIPTION	PR(
Α	30/01/2024	CONSTRUCTION DRAWINGS ISSUE	
С	15/03/2024	ADJUSTMENTS AS PER REQUEST DATED 21/02/24 & 11/03/24	l PR
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PROJECT				DRAWING TITLE		
PROPOSED NEW HOUSE				COVER SHEET		
53 MCCROSSIN AVENUE, BIRRONG NSW 2143						
FOR	MCKENZIE	DRAWN BY	PW	SCALE	DRAWING NO.	REV
PROJECT NO	23027	DESIGN	CUSTOM	NO SCALE	CD01	D

#### **GENERAL NOTES**

BUILDER TO VERIFY ALL DIMENSIONS AND LEVELS ON SITE PRIOR TO COMMENCEMENT OF WORK

INTERNAL DIMENSIONS ARE TO WALL FRAMING ONLY AND DOES NOT INCLUDE WALL LINING.

ALL WORK IN A MINE SUBSIDENCE DISTRICT MUST BE CONSTRUCTED IN ACCORDANCE WITH SUBSIDENCE ADVISORY NSW (SA NSW) APPROVAL.

ALL WORKS SHALL COMPLY WITH BUT NOT LIMITED TO THE NATIONAL CONSTRUCTION CODE SERIES (N.C.C) OF AUSTRALIAN AND THE CURRENT AUSTRALIAN STANDARDS LISTED IN NOTE 4.

AS 1288 - GLASS IN BUILDINGS - SELECTION AND INSTALLATION

AS 1562 - DESIGN AND INSTALLATION OF SHEET ROOF AND WALL CLADDING

AS 1684 - NATIONAL TIMBER FRAMING CODE

AS 2049 - ROOF TILES

AS 2050 - INSTALLATION OF ROOF TILES

AS 2870 - RESIDENTIAL SLAB AND FOOTINGS - CONSTRUCTION

AS/NZS 2904 - DAMP-PROOF COURSES AND FLASHINGS

AS2918 - DOMESTIC SOLID FUEL BURNING APPLIANCES - INSTALLATION

AS3500 - PLUMBING AND DRAINAGE

AS 3600 - CONCRETE STRUCTURES

AS 3660 - BARRIERS FOR SUBTERRANEAN TERMITES

AS 3700 - MASONRY IN BUILDINGS

AS 3740 - WATERPROOFING OF WET AREAS IN RESIDENTIAL BUILDINGS

AS 3786 - SMOKE ALARMS

AS 4055 - WIND LOADINGS FOR HOUSING

AS 4100 - STEEL STRUCTURES

THESE PLANS SHALL BE READ IN CONJUNCTION WITH ANY STRUCTURAL AND CIVIL ENGINEERING COMPUTIONS AND DRAWINGS.

SOIL CLASSIFICATION - REFER TO STRUCTURAL ENGINEERS SOIL TEST.

ALL BUILDINGS SHALL BE PROTECTED AGAINST TERMITE ATTACK IN ACCORDANCE WITH AS 3660.1 AND A DURABLE NOTICE SHALL BE PLACED IN THE METER BOX INDICATING TYPE OF BARRIER AND REQUIRED PERIODICAL **INSPECTIONS** 

SUB-FLOOR VENTILATION MINIMUM 7500MM SQ FOR EXTERNAL WALLS AND 1500MM SQ FOR INTERNAL WALLS BELOW BEARER.

STAIR REQUIREMENTS: MIN. TREAD 240MM, MIN. RISER 115MM, MAX. RISER 190MM, SPACE BETWEEN OPEN TREADS MAX. 125MM. TREADS TO BE NON SLIP SURFACE. BALUSTRADES: MIN. 1000MM ABOVE LANDINGS WITH MAX. OPENING OF 125MM AND IN ACCORDANCE WITH N.C.C 3.9.2 FOR STAINLESS STEEL BALUSTRADE, REFER TO TABLE 3.9.2.1 (WIRE BALUSTRADE CONSTRUCTION - REQUIRED WIRE TENSION AMD MAXIMUM PERMISSIBLE DEFLECTION) OF THE N.C.C

THE BUILDER SHALL TAKE ALL STEPS NECESSARY TO ENSURE THE STABILITY OF EXISTING AND NEW STRUCTURES THROUGH-OUT CONSTRUCTION

SMOKE ALARMS TO BE MAINS POWERED AND INSTALLED AS PER AS3786. LOCATIONS AS PER CURRENT BCA 3.7.2. SMOKE ALARMS TO BE INTERCONNECTED WHERE THERE IS MORE THAN ONE ALARM. INSTALLATION OF WOOD HEATERS TO COMPLY WITH AS2918. PROVIDE LOCAL AUTHORITIES WITH INSTALLATION AND COMPLIANCE CERTIFICATES.

EXHAUST FANS TO COMPLY WITH CURRENT BCA PART 3.8.5.2 SECTON C EXHAUST FAN TO BE SEALED AND DUCTED TO OUTSIDE OF DWELLING. NOTE: IF VENTING OCCURS DIRECTLY THROUGH WALL/ROOF ADJACENT TO FAN. THEN UNIT REQUIRES SELF CLOSING BAFFLES TO BE CLASSIFIED AS A 'SEALED' UNIT.

#### SITE WORKS

CUT AND BATTER ARE INDICATIVE. BATTER TO COMPLY WITH CURRENT BUILDING CODE OF AUSTRALIA TABLE 3.1.1. ALL CUTS AND FFL'S SHOWN ARE SUBJECT TO ENGINEERING ADVICE ONCE A SATISFACTION SOIL TEST HAS BEEN RECEIVED AND REVIEWED. ALL EARTHWORKS TO COMPLY TO THE CURRENT BCA PART 3.1.1 ALL EMBANKMENTS THAT ARE LEFT EXPOSED MUST BE STABILISED WITH VEGETATION OR SIMILAR TO PREVENT EROSION. EMBANKMENTS CANNOT EXCEED 2.0M IN HEIGHT WITHOUT THE AID OF RETAINING WALLS OR OTHER APPROVED TYPE OF SOIL RETAINING METHOD. ALL UNPROTECTED EMBANKMENTS MUST COMPLY WITH THE SLOPE RATIOS FOR SOIL TYPE IN TABLE 3.1.1.1 OF THE CURRENT BCA.

#### **ABBREVIATIONS**

BATH / SPA BB BREAKFAST BAR ΒE **BENCH** 

COL COLUMN TO STRUCTURAL ENG'S SPEC'S

CON CONCRETE CPT CARPET CK/O COOKTOP / OVEN DP DOWNPIPE. CONNECT TO

RAINWATER TANK OR EXISTING STORMWATER LINE DW DISHWASHER FIRE PLACE

FP FR FRIDGE/FREEZER FW FLOOR WASTE GS **GLASS SHOWER SCREEN** MI MIRROR

ORG **OVERFLOW RELIEF GULLY** R/A RETURN AIR

RH**RANGEHOOD** SL SKYLIGHT SR SHOWER SHOWER GRATE SRG

SK SINK LAUNDRY TUB TMB TIMBER DECK TR TOWEL RAIL

TRH **TOILET ROLL HOLDER** TERMINAL VENT TV VANITY BASIN V<sub>R</sub> VT VITRIFIED TILES - NON SLIP

WC WATER CLOSET WIP WALK IN PANTRY W/M WASHING MACHINE LOCATION NO STEP IN FLOOR LEVEL NO ST



ST DN

DOOR NUMBER. REFER TO SCHEDULE

STEP DOWN IN FLOOR LEVEL



WINDOW NUMBER, REFER TO SCHEDULE

#### WALL TYPE LEGEND

**BRICK VENEER WALL** 110mm SELECTED BRICK 40mm CAVITY



VAPOUR PERMEABLE SARKING SELECTED WALL INSULATION 90mm TIMBER STUDS @ 600 CTRS 10mm PLASTERBOARD OR AQUACHEK TO WET AREAS

**LIGHTWEIGHT CLADDING** 9.5mm JAMES HARDIE AXON VERTICLE CLADDING 35mm BATTENS VAPOUR PERMEABLE SARKING



SELECTED WALL INSULATION 90mm TIMBER STUDS @ 600 CTRS 10mm PLASTERBOARD OR AQUACHEK TO WET AREAS



STUD WALL 10mm PLASTERBOARD 90mm TIMBER STUDS @ 600 CTRS 10mm PLASTERBOARD OR AQUACHEK TO WET AREAS



#### BASIX COMPLIANCE REQUIREMENTS

Water Commitments				
Low Water Use Landscape Area (m2)		100		
Shower Head Rating		4 Star (>4.5 but <= 6 L/min)		
Toilet Flushing System Rating		6 Star		
Kitchen Taps Rating		6 Star		
Bathroom Taps Rating		6 Star		
On Demand Hot Water Reticu	lation System	No		
Rainwater Tank Capacity		Main House 5,000 It and Granny Flat 2,000L		
Rainwater Tank to be connected to		Outdoor taps, all toilets and laundry		
Greywater Treatment System	Installed	No		
Swimming Pool to have volume no greater >		N/A		
Thermal Commitments	;			
Floor - Concrete Slab		Nil		
External Walls (Min) - Brick Ve	eneer	N/A		
Internal Walls with shared garage (Min) - plasterboard		N/A		
Ceiling & Roof (Min) - Flat ceiling/pitched roof Medium Solar Absorptance (0.475 - 0.70)		N/A		
Energy Commitments				
Hot Water System		p to main house rage to granny flat		
Cooling Systems				

Cooling Systems	
Living Area	N/A
Bedroom Area	N/A
Install Day/Night Zoning	N/A
Heating Systems	
Living Area	N/A
Bedroom Area	N/A
Install Day/Night Zoning	N/A
Ventilation System	
Kitchen	Rangehood ducted to facade/roof manual on/off switch
Bathroom	Individual Fan ducted to facade/roof manual on/off switch
Laundry	Natural Ventilation
Artificial Lighting	•

Provided by Windows

Electric cooktop & electric oven

PROJECT NO 23027


Bedroom/study (5) Primary type of artificial lighting is fluorescent or LED


Living/Dining (3) Laundry Hallway

REV DATE DESCRIPTION

SINGLE BRICK WALL 110mm SELECTED BRICK


#### SEDIMENT AND EROSION CONTROL

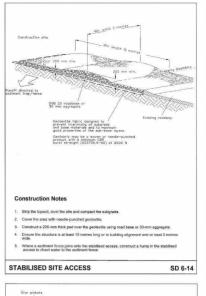

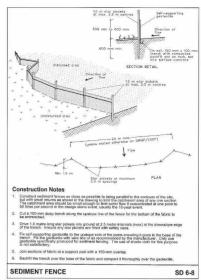

Where they are to be in place for more than 10 days, stabilise following the approved ESCP or SWMP to reduce the C-factor to less than 0,10.

STOCKPILES

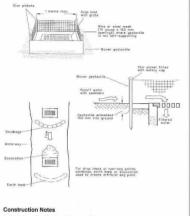

GEOTEXTILE INLET FILTER

SD 6-12

#### **INSULATION VALUES**

**EXTERNAL WALLS - R2.5 BULK INSULATION** INTERNAL WALLS - R2.0 BULK INSULATION CFILING - R6 and R4 1 BULK INSULATION

HEAT RECOVERY VENTILATION SYSTEM TO MAIN HOUSE

VENTIS VENTILATION SYSTEM TO THE GRANNY FLAT

DEVELOPMENT MUST COMPLY WITH THE REQUIREMENTS OF THE APPLICABLE WASTE DESIGN FOR NEW DEVELOPMENTS GUIDE

SOLAR P.V. SYSTEM TO MANUFACTURERS DESIGN AND **SPECIFICATION** 



DRAWING TITLE

# **FLOOD AFFECTED**

CONSTRUCTION DRAWINGS





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A 30/01/2024 CONSTRUCTION DRAWINGS ISSUE 15/03/2024 ADJUSTMENTS AS PER REQUEST DATED 21/02/24 & 11/03/24

Kitchen

Natural Lighting

Bathrooms/Toilets (3)

Cooking equipment

Other Requirements

PROPOSED NEW HOUSE 53 MCCROSSIN AVENUE, BIRRONG NSW 2143 DRAWN BY

DESIGN

CUSTOM

Primary type of artificial lighting is fluorescent or LED

Primary type of artificial lighting is fluorescent or LED

Primary type of artificial lighting is fluorescent or LED

Primary type of artificial lighting is fluorescent or LED

A fixed outdoor clothes drying line must be installed.

A well ventilated refrigerator space must be constructed


**GENERAL NOTES** SCALE 1:50 @ A3

DRAWING NO. REV **CD02** 

D

# REAL PROPERTY DESCRIPTION

LOT 68, DP 26982 AREA: 1,012 m<sup>2</sup>

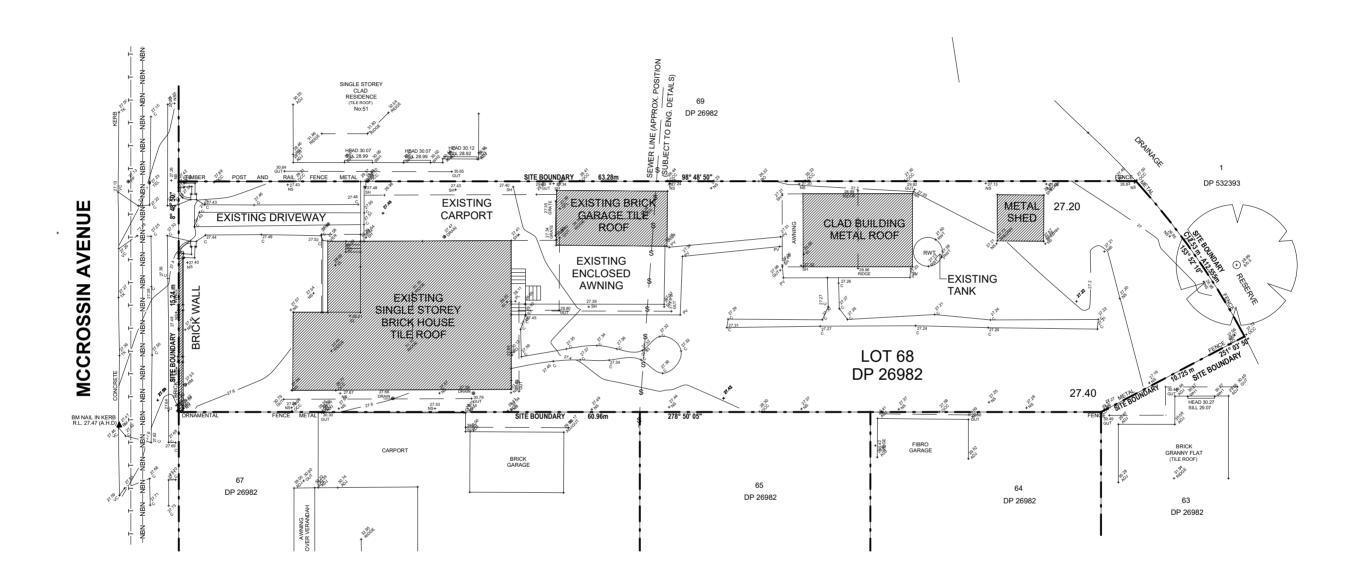


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# SITE ANALYSIS PLAN/EXISTING PLAN - PROPOSED

FLOOD AFFECTED

SCALE 1 : 250 @ A3


SCALE 1: 250 @ A3		CONSTRUCTION DRAWINGS
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COPYRIGHT ACT OF 1968 AND THE COPYRIGHT AMENDMENT (MORAL RIGHTS) BILL 1999 AND ARE NOT TO BE USED OR REPRODUCED WITHOUT THE WRITTEN CONSENT OF THE	FOR MCKENZIE DRAWN BY BP	SCALE DRAWING NO. REV
Australia PROPRIETOR.	PROJECT NO 23027 DESIGN CUSTOM	As1:200 @ A3 CD03 D

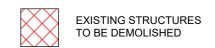

ALL DIMENSIONS ARE NOMINAL. UNDER GROUND CONDITIONS ARE ASSUMED UNTIL PROPERLY SURVEYED.

ASBESTOS REMOVAL TO COMPLY WITH NATIONAL OCCUPATIONAL HEALTH & SAFETY COMMISSION (NOHSC 2002)

ANY DAMAGE CAUSED BY DEMOLITION TO BE MADE GOOD

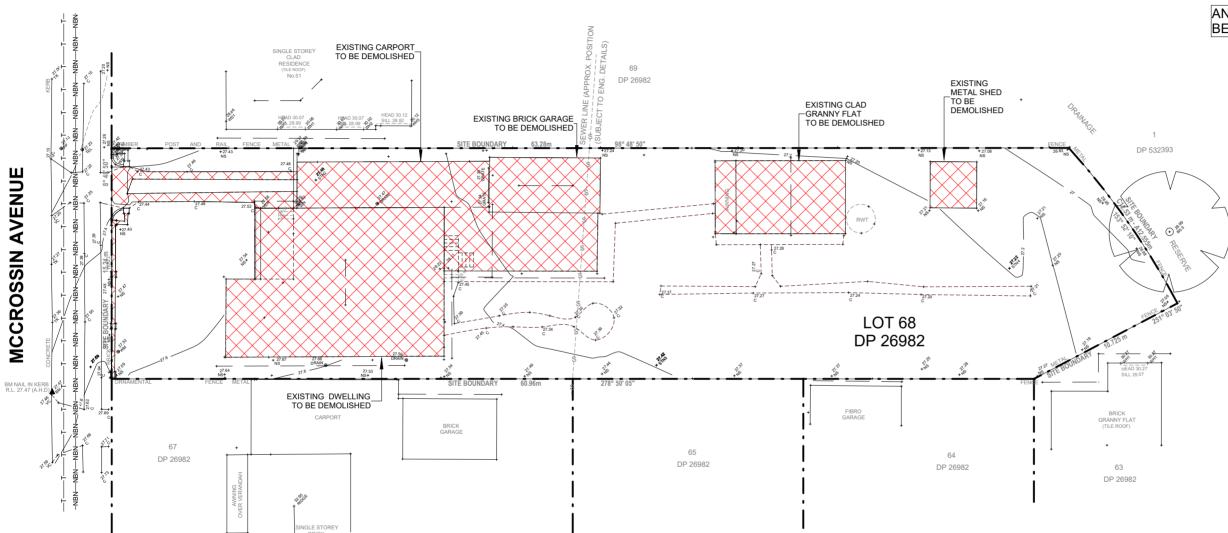

## **DEMOLITION PLAN - PROPOSED**

SCALE 1:250 @ A3





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Α	30/01/2024	CONSTRUCTION DRAWINGS ISSUE	
С	15/03/2024	ADJUSTMENTS AS PER REQUEST DATED 21/02/24 & 11/03/24	PRO
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CONSTRUCTION DRAWINGS DRAWING TITLE

**FLOOD AFFECTED** 

PROPOSED NEW HOUSE 53 MCCROSSIN AVENUE, BIRRONG NSW 2143			DEMOLITION PLAN - PROPOSED				
FOR	MCKENZIE	DRAWN BY	BP	SCALE	DRAWING NO.	REV	
PROJECT NO	23027	DESIGN	CUSTOM	As1:200 @ A3	CD04	D	

SIT	TE - AREAS (CALCULATED)	
ID	Name	Area

H-2	IMPERMEABLE	64 m²	
H-1	IMPERMEABLE	258 m²	
H-3	IMPERMEABLE	165 m²	
		487 m²	

S-3	PERMEABLE	20 m <sup>2</sup>
S-1	PERMEABLE	301 m <sup>2</sup>
S-2	PERMEABLE	210 m <sup>2</sup>
-		531 m²


1018 m<sup>2</sup>

REAL PROPERTY DESCRIPTION

LOT 68, DP 26982 AREA: 1,012 m<sup>2</sup>





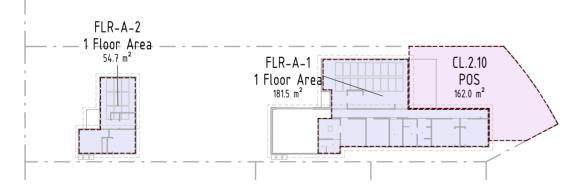

AREA TYPE	REQUIRED	PROPOSED	COMPLIES
FSR PRIMARY DWELLING SECONDARY DWELLING COMBINED	50% 60m² 50%	17.8% 54.7m² 23%	YES YES YES
LANDSCAPE [cl.2.29] FRONTAGE	45%	58%	YES
PRIVATE OPEN SPACE POS - (Min 5.0m)	80m²	162m²	YES

PROPOSED AREAS SCALE 1:500 @ A3

# **FLOOD AFFECTED**

CONSTRUCTION DRAWINGS





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PROJECT				DRAWING TITLE			
PROPOSED N	EW HOUSE			AREA PLAN - PROPOSED			
53 MCCROSSIN AVENUE, BIRRONG NSW 2143							
FOR	MCKENZIE	DRAWN BY	BP	SCALE	DRAWING NO.	REV	
PROJECT NO	23027	DESIGN	CUSTOM	1:200 @ A3	CD05	D	
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REFER SSR DATED 14/05/2024 REF. WP-SIAONL-941/2024

#### FLOOD AFFECTED: STORMWATER INFRASTRUCTURE

THE SITE MAY BE AFFECTED BY THE FOLLOWING COUNCIL & SYDNEY WATER STORMWATER SYSTEM COMPONENTS. AN OPEN CHANNEL AND ASSOCIATED DRAINAGE RESERVE LOCATED ALONG EASTERN SITE BOUNDARY ADJACENT TO THE SITE

1% AEP (100 YEAR ARI): 26.90M AHD FREEBOAD: 0.5M PMF (PROBABALE MAXIMUM FLOOD): 28.2M AHD

PROPOSED HABITABLE FLOOR LEVELS

PRIMARY DWELLING: 27 70M AHD SECONDARY DWELLING: 27.90M AHD

#### STORMWATER NOTE

- NON-HABITABLE FLOOR LEVELS SHOULD BE NO LOWER THAN THE 20-YEAR FLOOD UNLESS JUSTIFIED BY A SPECIFIC ASSESSMENT.
- ALL HABITABLE FLOOR LEVELS TO BE EQUAL TO OR GREATER THAN THE 100-YEAR FLOOD LEVEL PLUS FREEBOARD
- ALL STRUCTURES TO HAVE FLOOD COMPATIBLE BUILDING COMPONENTS BELOW THE 100-YEAR FLOOD LEVEL PLUS FREEBOARD
- APPLICANT TO SATISFY COUNCIL THAT THE PROPOSAL WILL NOT INCREASE FLOOD EFFECTS, A REPORT MAY BE REQUIRED
- COUNCIL MAY REQUIRE CREATION OF AN EASEMENT OR RESTRICTION ON LAND'
- IN THE CASE OF GARAGES. THE MINIMUM SURFACE LEVEL SHALL BE AS HIGH AS PRACTICAL BUT NO LOWER THAN THE 20-YEAR FLOOD. SURFACE LEVELS
- SHOULD ALSO BE DETERMINED HAVING REGARD TO THE CONTROL NUMBER 4 BELOW RELATING TO DEPTHS OF INUNDATION OVER DRIVEWAYS. THE LEVEL OF THE DRIVEWAY PROVIDING ACCESS BETWEEN THE ROAD AND THE PARKING SPACES SHOULD BE AS HIGH AS PRACTICAL
- RESTRAINTS OR VEHICLE BARRIERS TO BE PROVIDED TO PREVENT FLOATING VEHICLES LEAVING THE SITE IN A 100-YEAR FLOOD

#### **EVACUATION**

- RELIABLE ACCESS FOR PEDESTRIANS OR VEHICLES IS REQUIRED FROM THE BUILDING, COMMENCING AT A MINIMUM LEVEL EQUAL TO THE LOWEST HABITABLE FLOOR LEVEL TO AN AREA OF REFUGE ABOVE THE PMF. SUCH A REFUGE MAY COMPRISE A MINIMUM OF 20% OF THE GROSS FLOOR AREA OF THE DWELLING BEING ABOVE THE PMF LEVEL. AN ENGINEER'S REPORT MAY BE REQUIRED.
- THE DEVELOPMENT SHOULD BE CONSISTENT WITH ANY FLOOD EVACUATION STRATEGY, FLOOD PLAN OR SIMILAR STRATEGY THAT HAS BEEN ADOPTED BY

#### **REAL PROPERTY DESCRIPTION**

LOT 68. DP 26982 AREA: 1,012 m<sup>2</sup>

#### **LEGEND**

**EXISTING TREE** 

**EXISTING NBN CABLE** 

(s)

---s---s-

**EXISTING SEWER LINE** 

—x——x—

SEDIMENT CONTROL BARRIER TELECOMMUNICATIONS LINE

**EXISTING SEWER MAN HOLE** 

-| F |---| F |-

4/0.2 NS

SH

ΤK

VC

WM

TEL


TEMPORARY SECURITY FENCING

AHD AUSTRALIAN HEIGHT DATUM RL REDUCED LEVEL С **EDGE OF CONCRETE** PLPATIO LEVEL VL EL VERANDAH LEVEL **ENTRY LEVEL** GFL GARAGE FLOOR LEVEL **GUT** 

TOP OF GUTTER TREE SPREAD / TRUNK DIAMETER

NATURAL SURFACE SPOT HEIGHT TOP OF KERB VEHICLE CROSSING

WATER METER POWER POLE **TELSTRA** 

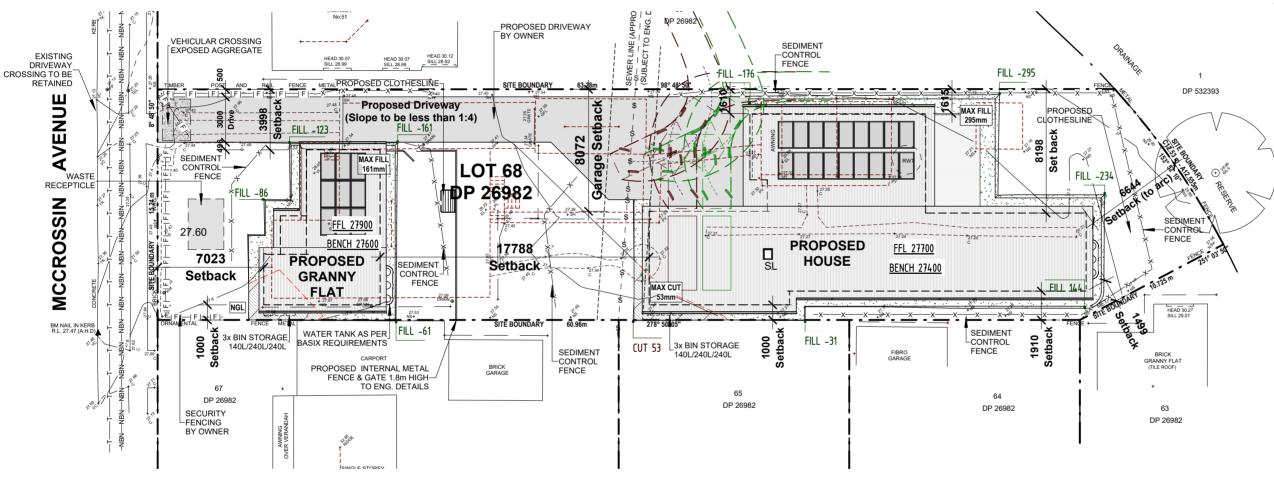

SITE PLAN - PROPOSED

CONSIDERATIONS OF THE RELEVANT CATEGORY.

SCALE 1: 250 @ A3

NOTES:

#### STORMWATER SYSTEM SUBJECT TO HYDRAULIC ENGINEERS DESIGN AND DETAILS

SUBJECT TO SEWER PEGOUT (INCL. DEPTH AND Z.O.I) TO FUTURE ENG. DETAILS. **ACTUAL POSITION TO BE DETERMINED** 

SUBJECT TO COUNCIL APPROVAL

# **FLOOD AFFECTED**

CONSTRUCTION DRAWINGS

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ANY FENCING THAT FORMS PART OF A PROPOSED DEVELOPMENT IS SUBJECT TO THE RELEVANT FLOOD EFFECT AND STRUCTURAL SOUNDNESS

APPLICANT TO DEMONSTRATE THAT FENCES (NEW OR REPLACEMENT FENCE) WOULD CREATE NO IMPEDIMENT TO THE FLOW OF FLOODWATERS ANY PROPOSED OR FUTURE HEATING OR AIR CONDITIONING SYSTEMS TO BE INSTALLED ABOVE THE RELEVANT FLOOD LEVEL WHERE POSSIBLE

DEVELOPMENT MUST COMPLY WITH THE REQUIREMENTS OF THE APPLICABLE WASTE DESIGN FOR NEW DEVELOPMENTS GUIDE

REV DATE DESCRIPTION **PROJECT** A 30/01/2024 CONSTRUCTION DRAWINGS ISSUE 15/03/2024 ADJUSTMENTS AS PER REQUEST DATED 21/02/24 & 11/03/24

PROPOSED NEW HOUSE 53 MCCROSSIN AVENUE, BIRRONG NSW 2143 DRAWN BY **MCKENZIE** PROJECT NO 23027 DESIGN CUSTOM

SITE PLAN - PROPOSED SCALE DRAWING NO. **CD06** 1:200 @ A3

DRAWING TITLE




Boronia - Heaven Scent Boronia Megastigma REAL PROPERTY DESCRIPTION

LOT 68, DP 26982 AREA: 1,012 m<sup>2</sup>



Lavender Little Poppet lavandula angustifolia little poppet

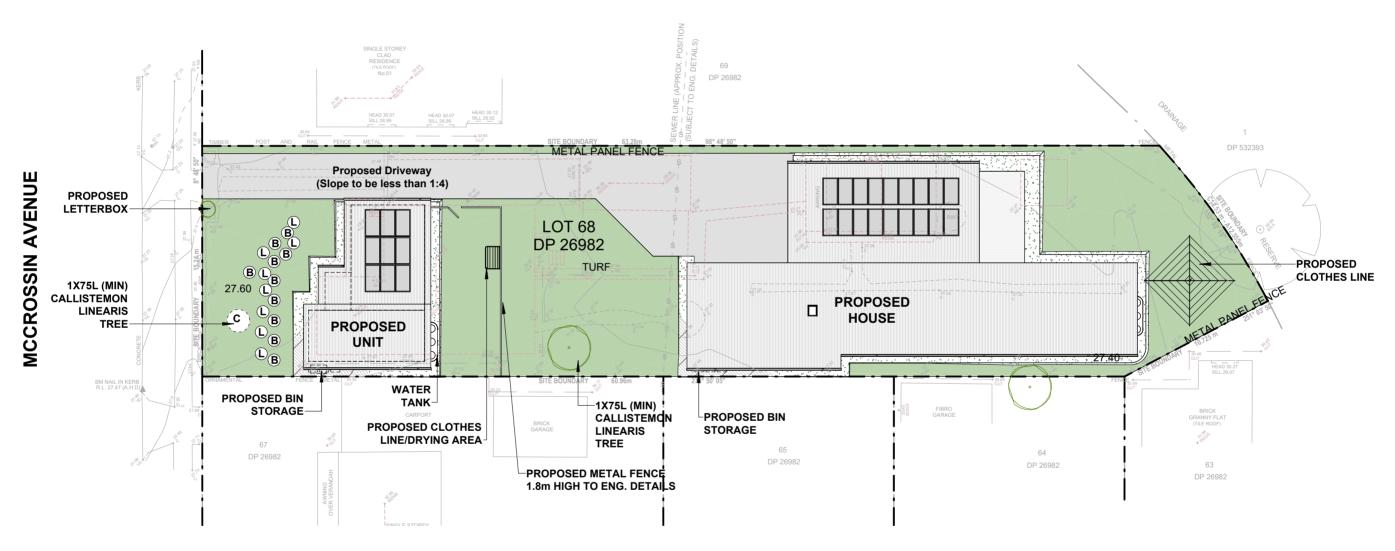

LANDSCAPE PLAN - PROPOSED

SCALE 1: 250 @ A3

#### NOTES:

- DEVELOPMENT MUST RETAIN AND PROTECT ANY SIGNIFICANT TREES ON THE SITE AND ADJOINING SITES
- PLANT AT LEAST ONE 75 LITRE TREE BETWEEN THE DWELLING HOUSE AND THE PRIMARY STREET FRONTAGE (REFER TO THE LANDSCAPE GUIDE FOR A LIST OF SUITABLE TREES IN CANTERBURY BANKSTOWN)

## FLOOD AFFECTED

CONSTRUCTION DRAWINGS





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PROJECT
PROPOSED NEW HOUSE
53 MCCROSSIN AVENUE, BIRRONG NSW 2143

FOR MCKENZIE DRAWN BY BP
PROJECT NO 23027 DESIGN CUSTOM 1:200 @ A3


CD07

DRAWING TITLE
LANDSCAPE PLAN - PROPOSED


SCALE
LANDSCAPE PLAN - PROPOSED

1:200 @ A3

CD07

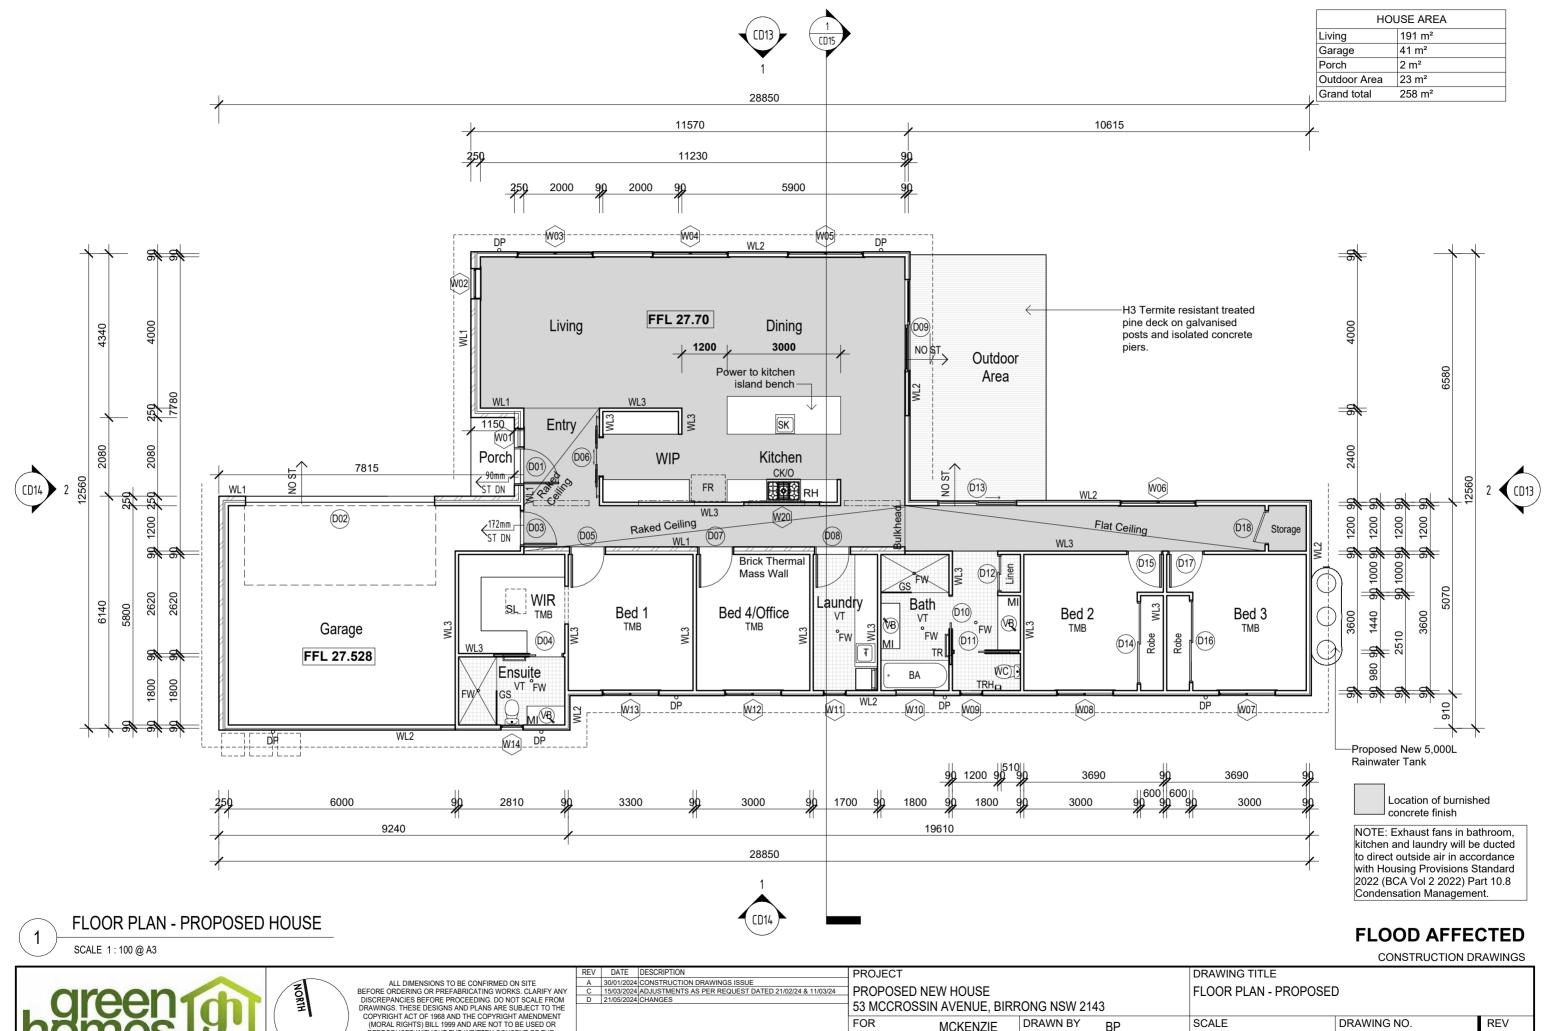

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#### SLAB SETOUT LEGEND

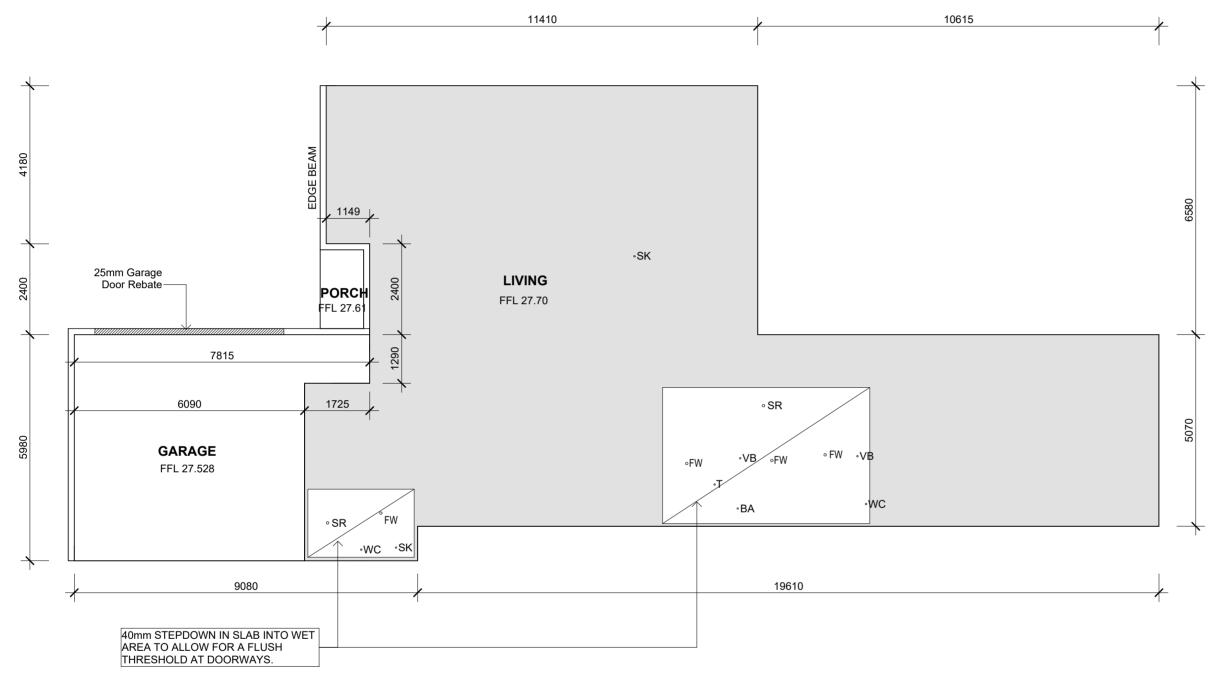BA BATH

FW FLOOR WASTE SR SHOWER

SRG SHOWER GRATE

SK SINK

T LAUNDRY TUB
VB VANITY BASIN
WC WATER CLOSET

#### **SLAB SETOUT NOTES**

ALL MATERIALS AND WORK PRACTICES SHALL COMPLY WITH, BUT NOT LIMITED TO THE BUILDING REGULATIONS 2015, THE BUILDING CODE OF AUSTRALIA AND ALL RELEVANT CURRENT AUSTRALIAN STANDARDS (AS AMENDED) REFERRED TO THEREIN.

THESE DRAWINGS SHALL BE READ IN CONJUNCTION WITH ALL RELEVANT STRUCTURAL AND ALL OTHER CONSULTANTS DRAWINGS / DETAILS AND WITH ANY OTHER WRITTEN INSTRUCTIONS ISSUED IN THE COURSE OF THE CONTRACT.

FIGURED DIMENSIONS TAKE PRECEDENCE OVER SCALED DIMENSIONS.

THE BUILDER AND SUBCONTRACTORS SHALL CHECK AND VERIFY ALL DIMENSIONS, SETBACKS, LEVELS AND SPECIFICATIONS AND ALL OTHER RELEVANT DOCUMENTATION PRIOR TO THE COMMENCEMENT OF ANY WORK. REPORT ALL DISCREPANCIES TO DESIGNER FOR CLARIFICATION.

# SLAB SETOUT PLAN - PROPOSED

SCALE 1:100@A3

FLOOD AFFECTED

CONSTRUCTION DRAWINGS

D





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REV	DATE	DESCRIPTION	I PROJECT	
Α	30/01/2024	CONSTRUCTION DRAWINGS ISSUE		
С	15/03/2024	ADJUSTMENTS AS PER REQUEST DATED 21/02/24 & 11/03/24	] PROPOSED N	EW HOL
D	21/05/2024	CHANGES		
			53 MCCROSSI	N AVEN
			FOR	MCKE
			PROJECT NO	23027

OJECT OPOSED NEW HOUSE MCCROSSIN AVENUE, BIRRONG NSW 2143 R MCKENZIE DRAWN BY BF

DESIGN

CUSTOM


DRAWING TITLE

SLAB SETOUT PLAN

SCALE DRAWING NO. REV

1:100 @ A3

CD09

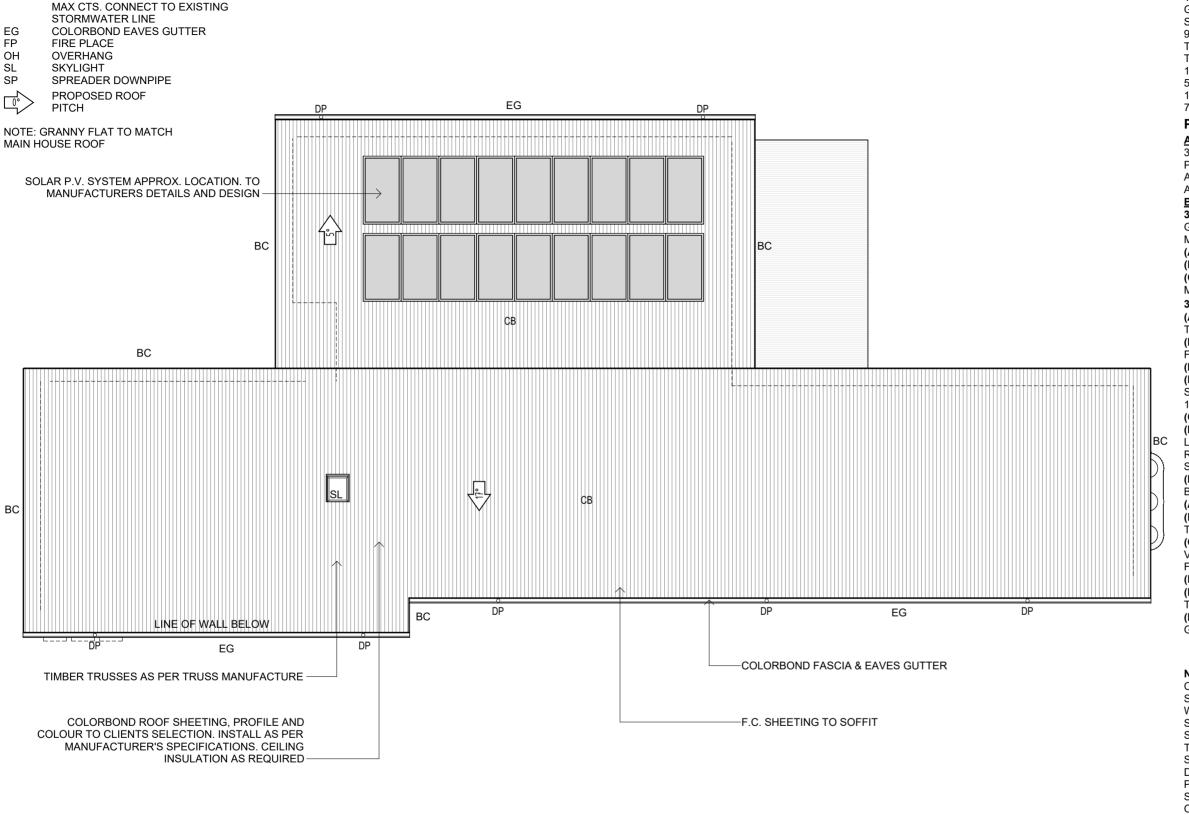

# ROOF PLAN NOTES STORMWATER:

110MM DIA. CLASS 6 UPVC STORMWATER LAID TO A MINIMUM GRADE OF 1:100 AND CONNECTED TO A LEGAL POINT OF STORMWATER DISCHARGE. PROVIDE INSPECTION OPENINGS AT 900MM CTRS AND AT EACH CHANGE OF DIRECTION. THE COVER TO UNDERGROUND STORMWATER DRAINS SHALL BE NOT LESS THAN-

100MM - UNDER SOIL

50MM - UNDER PAVED OR CONCRETE AREAS

100MM - UNDER REINFORCED CONCRETE OR PAVED DRIVEWAYS 75MM - UNDER REINFORCED CONCRETE DRIVEWAYS

#### **PLUMBING NOTES:**

#### A ACCEPTABLE CONSTRUCTION MANUAL

3.5.2.0 PERFORMANCE REQUIREMENT

P2.2.1 IS SATISFIED FOR GUTTER AND DOWNPIPES IF THEY ARE DESIGNED AND CONSTRUCTED IN ACCORDANCE WITH AS3500.3 - STORMWATER DRAINAGE INSTALLATIONS

#### **B ACCEPTABLE CONSTRUCTION PRACTICE**

#### 3.5.1.2 MATERIALS

GUTTERS, DOWNPIPES AND FLASHINGS MUST BE MANUFACTURED IN ACCORDANCE WITH-

(A) AS2179.1 FOR METAL; AND

(B) AS1273 FOR UPVC COMPONENTS; AND

(C) BE COMPATIBLE WITH ALL UPSTREAM ROOFING

MATERIALS IN ACCORDANCE WITH 3.5.1.3(C)

#### 3.5.2.4 INSTALLATION OF GUTTERS

(A) GUTTERS MUST BE INSTALLED WITH A FALL NOT LESS THAN-

(I) 1:500 FOR EAVES GUTTERS, UNLESS FIXED TO METAL FASCIAS; AND

(II) 1:100 FOR BOX GUTTERS

(B) EAVES GUTTERS MUST BE SUPPORTED BY BRACKETS SECURELY FIXED AT STOP ENDS AND AT NOT MORE THAN 1.2M CTRS.

(C) VALLEY GUTTERS ON A ROOF PITCH-

(I) MORE THAN 12.5 DEGREES MUST HAVE A WIDTH OF NOT LESS THAN 400MM AND TO BE WIDE ENOUGH TO ALLOW THE ROOF COVERING TO OVERHANG NOT LESS THAN 150MM EACH SIDE OF THE GUTTER; OR

(II) NOT MORE THAN 12.5 DEGREES MUST BE DESIGNED AS A BOX GUTTER. 3.5.2.5 DOWNPIPES - SIZE AND INSTALLATION (A) DOWNPIPES MUST BE SECURELY FIXED TO WALLS

(B) THE SPACING BETWEEN DOWNPIPES MUST NOT BE MORE THAN 12M.

(C) DOWNPIPES MUST BE FIXED AS CLOSE AS POSSIBLE TO VALLEY GUTTERS AND, IF THE DOWNPIPE IS MORE THAN 12M FROM THE VALLEY, PROVISION FOR OVERFLOW MUST BE MADE. (D) DOWNPIPES MUST-

(I) BE COMPATIBLE WITH OTHER ROOFING MATERIALS USED IN THE ROOFING SYSTEM IN ACCORDANCE WITH 3.5.1.3. (C) (II) BE SELECTED IN ACCORDANCE WITH APPROPRIATE EAVES GUTTER SECTION AS SHOWN IN TABLE 3.5.2.2.

NOTES: ROOF CLADDING, GUTTERS & DOWNPIPES AND WALL CLADDING SHALL COMPLY WITH BCA PART 3.5. THE BUILDER SHALL INSTALL ROOF CLADDING, GUTTERS & DOWNPIPES AND WALL CLADDING TO THE APPROPRIATE REQUIREMENTS AND STANDARDS FOR THE SELECTED MATERIAL. THE BUILDER SHALL TAKE ALL STEPS NECESSARY TO ENSURE WATER TIGHTNESS OF THE BUILDING. DOWN PIPES AND GUTTERS SHALL BE OF A SIZE AND LOCATION INDICATED ON THE DRAWINGS AND IF NOT SPECIFICALLY NOTED COMPLY WITH PART 3.5.2. DOWNPIPES SHALL BE LOCATED AT A MAXIMUM SPACING OF 12M AND WITHIN 1.2M OF A VALLEY (UNLESS AN OVERFLOW IS PROVIDED.)

#### **FLOOD AFFECTED**

CONSTRUCTION DRAWINGS

REV

D



**ROOF LEGEND** 

СВ

DP

COLORBOND BARGE CAPPING

COLORBOND ROOF SHEETING

100 DIA. PVC DOWNPIPE AT 12.0m



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D	21/05/2024	CHANGES	50 MOOD
			53 MCCRC
			FOR
			1 011

 PROPOSED NEW HOUSE

 53 MCCROSSIN AVENUE, BIRRONG NSW 2143

 FOR
 MCKENZIE
 DRAWN BY
 BP

 PROJECT NO
 23027
 DESIGN
 CUSTOM


ROOF PLAN

SCALE DRAWING NO.

As 1:100 @ A3

CD10

DRAWING TITLE

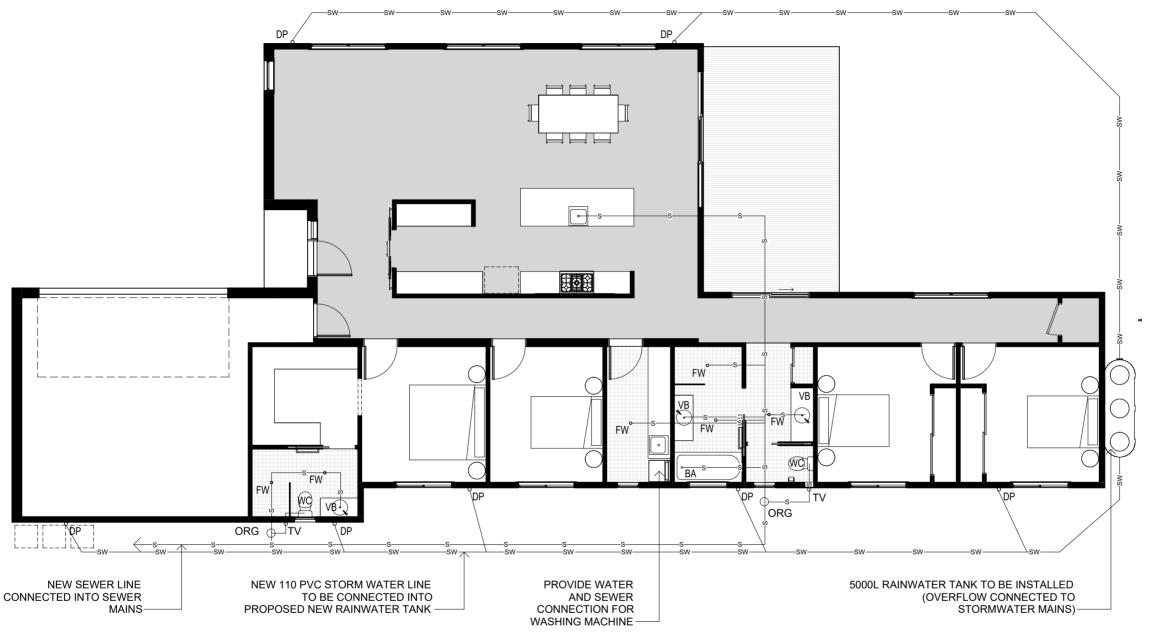

#### LEGEND

BA DP FW SR SD SK T VB WB	BATH DOWNPIPE FLOOR WASTE SHOWER STRIP DRAIN SINK LAUNDRY TUB VANITY BASIN WASH BASIN WATER CLOSET
s	PROPOSED NEW SEWER LINE
SW	PROPOSED NEW STORMWATER LINE
SRG	STRIP GRAIN
ORG O	OVER FLOW RELIEF GULLY
TV O	TERMINAL VENT

#### **DRAINAGE NOTES**

DRAINAGE TO BE DESIGNED AND CONSTRUCTED IN ACCORDANCE WITH AS3500 AND LOCAL AUTHORITY.

STORMWATER PIPES TO BE UPVC CLASS HD

SEWER PIPES TO BE UPVC CLASS SH

PROVIDE 20Ø K2 POLYETHYLENE WATER RETICULATION

TYPE B STOP VALVE TO BE LOCATED ADJACENT TO

BACKFILL ALL TRENCHES BENEATH VEHICLE PAVEMENT AND SLABS ON GRADE TO FULL DEPTH WITH 20 FCR.

PROVIDE OVERFLOW RELIEF GULLY WITH TAP OVER.LNVERT LEVEL TO BE A MINIMUM OF 150MM BELOW FINISHED

CUT AND BATTER ARE INDICATIVE. BATTER TO COMPLY WITH CURRENT BUILDING CODE OF AUSTRALIA TABLE 3 1 1 1

AG DRAIN REQUIRED AROUND PERIMETER OF DWELLING FOR ALL CLASS M,H,E SITES. LOCATE AG DRAIN NOT CLOSER THAN 1.5M FROM FOOTING,IN ACCORDANCE WITH AS2870 2011 SECTION 5.6.

PROVIDE SURFACE DRAINAGE IN ACCORDANCE WITH AS2870 SECTION 5.6.3.

PROVIDE FLEXIBLE JOINTS IN ALL DRAINAGE EMERGING FROM UNDERNEATH OR ATTACHED TO BUILDING IN ACCORDANCE WITH AS2870 2011 SECTION 5.6.4 FOR ALL CLASS H&E SITES. REFER GEOTECH FOR CLASS.

DOWNPIPES AND GUTTERS DESIGNED IN ACCORDANCE WITH AS/NZS 3500.3 2003.

#### STORMWATER SYSTEM AND DETAILS SUBJECT TO HYDRAULIC ENGINEERS DETAILS

#### **FLOOD AFFECTED**

CONSTRUCTION DRAWINGS

REV

D





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| REV | DATE | DESCRIPTION | A | 30/01/2024 | CONSTRUCTION DRAWINGS ISSUE | C | 15/03/2024 | ADJUSTMENTS AS PER REQUEST DATED 21/02/24 & 11/03/24 | PROPOSED NEW HO | 53 MCCROSSIN AVEN | FOR | MCKE | PROJECT NO | 23027

PROJECT
PROPOSED NEW HOUSE
53 MCCROSSIN AVENUE, BIRRONG NSW 2143
FOR MCKENZIE DRAWN BY

DESIGN

CUSTOM

SERVICES PLAN

SCALE

As1:100 @ A3

DRAWING TITLE

DRAWING NO.

CD11



# ELECTRICAL LEGEND DOWN LIGHT P PENDANT LIGHT EXTERNAL LIGHT POINT LIGHT SWITCH LIGHT FLUORESCENT LIGHTS EXHAUST FAN AND LIGHT SINGLE GPO DOUBLE GPO - 300mm 100 DOUBLE GPO - 1100mm M SMOKE ALARM CEILING FAN

#### **ELECTRICAL NOTE**

ALL SYMBOLS AND SYMBOL LOCATIONS ARE INDICATIVE ONLY AND TO BE USED AS A GUIDE ONLY. SYMBOLS AND LOCATIONS ARE NOT DRAWN TO SCALE.

BOTH POWER POINTS FOR THE UBI & COOKTOP SHOULD SIT TO THE RIGHT HAND SIDE OF THE OVEN.

10AMP GPO FOR UBO ON SEPARATE CIRCUIT @ 750H

SPP FOR COOKTOP @ 750H SPP @ 1700H FOR RANGEHOOD

NOTE: LOCATIONS OF ALL ELECTRICAL AND LIGHTING TO BE CONFIRMED WITH CLIENT BEFORE CONSTRUCTION.

SMOKE ALARM TO BE INSTALLED AS PER AS3786-1993 AND THE NCC PART 3.7.2

NOTE: LIGHT SWITCHING SET LOWER - ACCESSIBILITY PROVISIONS.

## **FLOOD AFFECTED**

CONSTRUCTION DRAWINGS





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PROJECT
PROPOSED NEW HOUSE
53 MCCROSSIN AVENUE, BIRRONG NSW 2143
FOR MCKENZIE DRAWN BY B

DESIGN

CUSTOM

DRAWING TITLE ELECTRICAL PLAN


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A:1:100 @ A3

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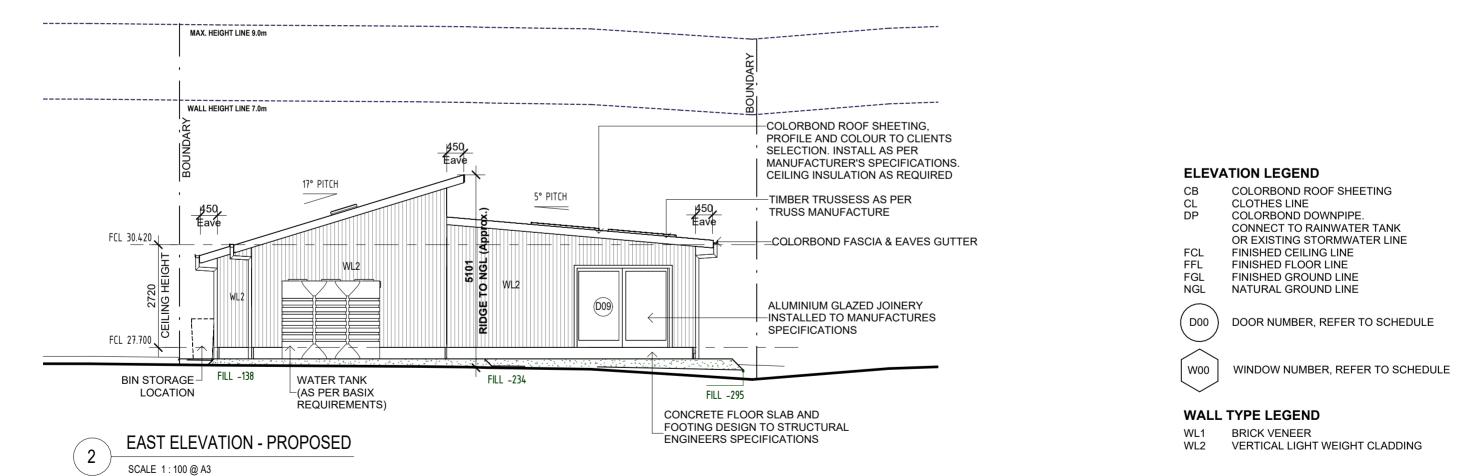
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# NORTH ELEVATION - PROPOSED

SCALE 1:100 @ A3



# **FLOOD AFFECTED**

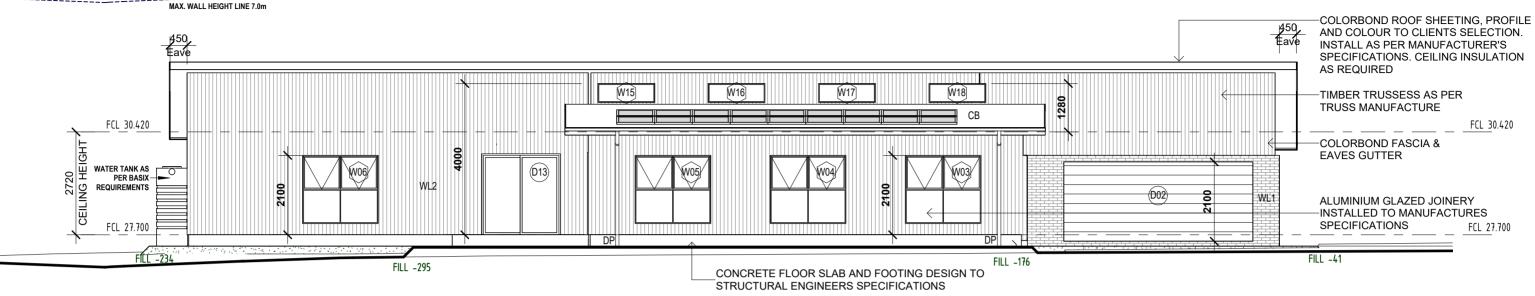CONSTRUCTION DRAWINGS

REV

D





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			FOR	MCKE
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ROJECT
ROPOSED NEW HOUSE
MCCROSSIN AVENUE, BIRRONG NSW 2143
DR MCKENZIE DRAWN BY [

DESIGN

CUSTOM


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ELEVATIONS - PROPOSED


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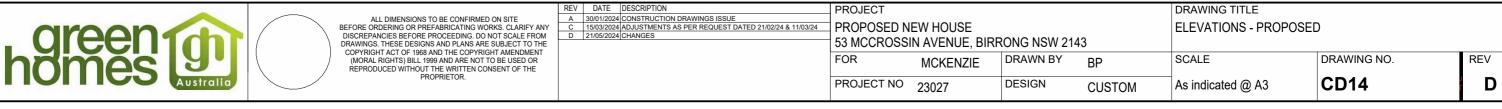
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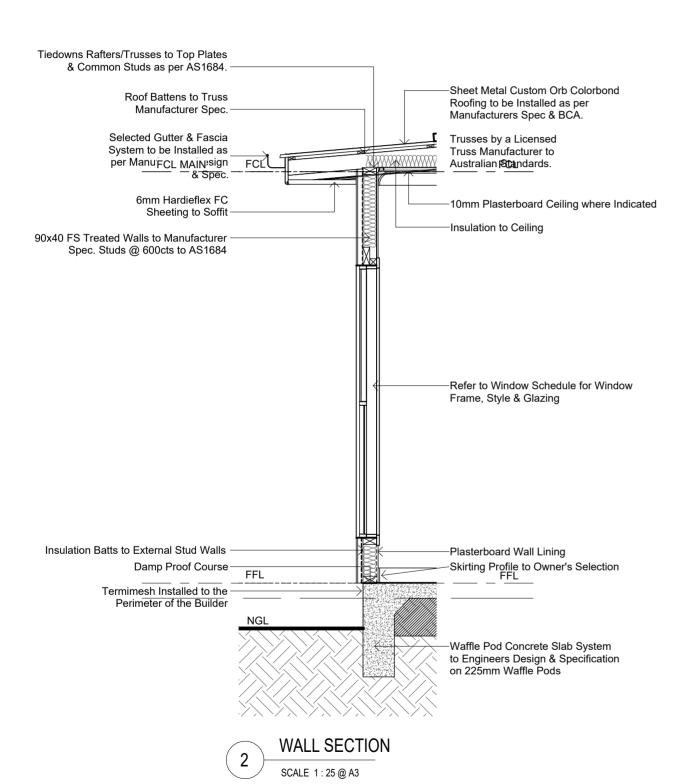
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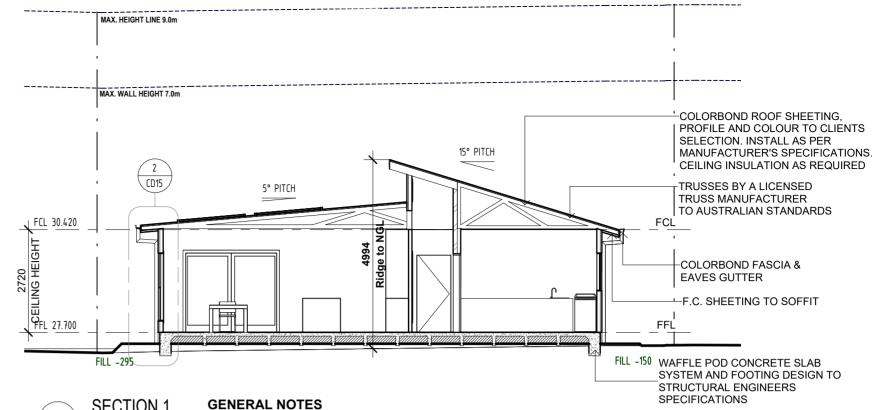
CD13







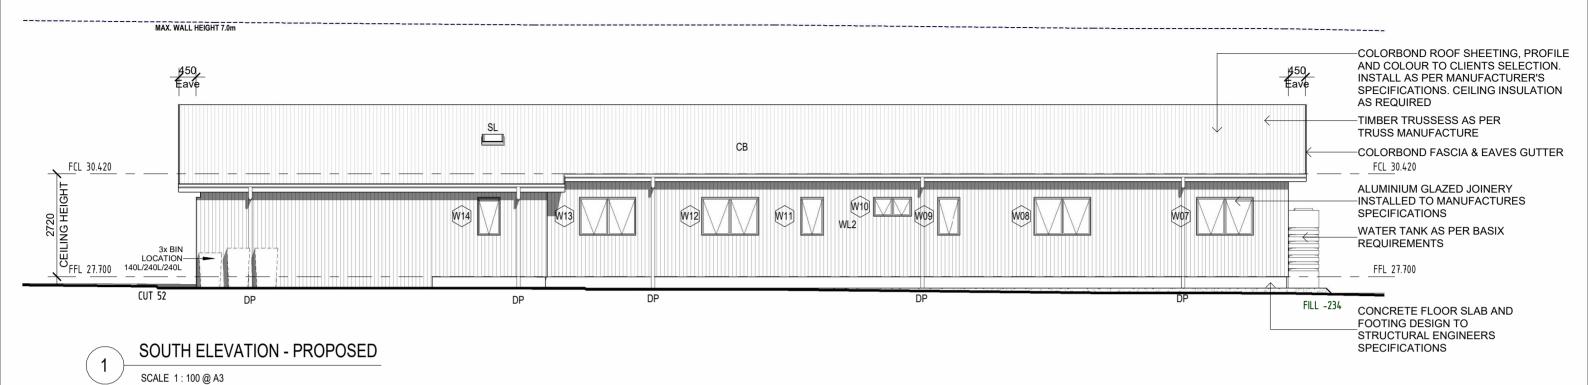

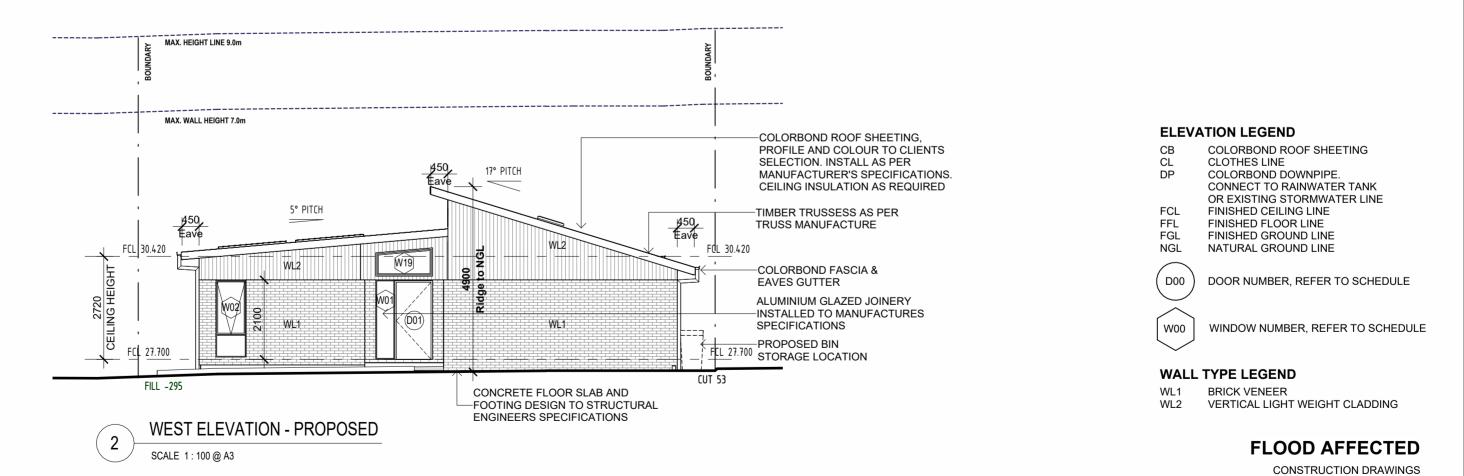

**SECTION 1** 

SCALE 1:100 @ A3

DO NOT SCALE FROM THIS DRAWING. ALL DIMENSIONS TO BE CHECKED ON SITE. ALL WORK TO BE CARRIED OUT IN ACCORDANCE WITH RELEVANT CODES. IT IS THE BUILDERS RESPONSIBILITY TO ENGAGE PROFESSIONAL SITE SUPERVISION FOR ALL STRUCTURAL WORKS. ANY DISCREPANCIES ON SITE/AND OR DRAWINGS SHOULD BE REPORTED TO GREEN HOME AUSTRALIA BEFORE PROCEEDING SUBJECT TO WRITTEN INSTRUCTIONS.

#### **STEELWORK:**

ALL STEELWORK TO BE GRADE 250 UNLESS NOTED OTHERWISE. SQUARE AND RECTANGULAR HOLLOW SECTIONS TO BE GRADE 350. FABRICATION AND ERECTION GENERALLY TO COMPLY WITH AS1250 - STEEL STRUCTURES CODE. ALL WELDS TO BE 5MM FILLET OR FULL STRENGTH BUTT WELDS UNLESS OTHERWISE NOTED. PROVIDE ALL CLEATS, BRACKETS, HOLES ETC. NECESSARY TO COMPLETE THE WORK. ALL STEEL GUSSET PLATES TO BE 6MM THICK WITH HOLE CENTRES 2 DIAMETERS FROM EDGES, UNLESS OTHERWISE NOTED. ALL HOLES TO BE DRILLED OR PUNCHED 2MM OVERSIZE UNLESS NOTED OTHERWISE. ALL STEELWORK TO BE PRIME PAINTED PRIOR TO ERECTION, EXCEPT STEELWORK WHICH IS TO BE EMBEDDED IN CONCRETE (WHICH MUST BE FREE FROM ALL GREASE, PAINT AND LOOSE PARTICLES)ALL BOLTS CONNECTING STEEL TO STEEL TO BE M12 MINIMUM UNLESS NOTED OTHERWISE. PROVIDE ALL BRACING AS NECESSARY DURING ERECTION.

#### **FOOTINGS:**

CONCRETE STRENGTH TO BE 20 MPA MINIMUM UNLESS NOTED OTHERWISE (EXCEPT BLINDING CONCRETE - MINIMUM 15 MPA). ALL FOOTING PADS ARE TO BE FOUNDED ON SOIL OF 100KPA MINIMUM AND MUST BE OF THE MINIMUM SIZE SHOWN ON THE WORKING DRAWINGS. IF 100 KPA BEARING CAPACITY CANNOT BE ACHIEVED, CONSULT WITH THE ENGINEER BEFORE PROCEEDING, ALL EXCAVATIONS TO BE CLEAN AND DRY BEFORE POURING CONCRETE AND APPROVAL OF BUILDING AUTHORITY OBTAINED.

#### **CONCRETE:**

ALL CONCRETE TO BE ACCURATELY FORMED TO THE DIMENSIONS SHOWN ON THE DRAWINGS WITH NO ALLOWANCE FOR FINISHES. REINFORCEMENT SHOULD BE INSPECTED BY COUNCIL OR A PRIVATE CERTIFIER AS ARRANGED BY THE BUILDER. FORMWORK IS TO REMAIN IN PLACE FOR A MINIMUM OF SEVEN (7) DAYS.

THE PROPERTIES OF THE CONCRETE AT 28 DAYS TO BE AS FOLLOWS:

FOOTING: 20 MPA 75MM SLUMP 20MM AGGREGATE

SLAB: 20 MPA 75MM SLUMP 14MM AGGREGATE

CONCRETE IS TO BE MECHANICALLY VIBRATED FREE OF AIR VOIDS DURING PLACEMENT TAKING CARE NOT TO DISPLACE

CONTINUOUSLY CURE CONCRETE BY PONDING OR OTHER APPROVED METHOD FOR 7 DAYS AFTER THE POURING.

ALL REINFORCEMENT TO BE ACCURATELY PLACED AND WIRED INTO POSITION, TAKING CARE NOT TO PUNCTURE THE WATERPROOF MEMBRANE WHERE SPECIFIED. SUPPORT ALL REINFORCEMENT ON BAR CHAIRS AT 1200 MM CTRS. WIRE FABRIC TO COMPLY WITH

AS1304 WITH MINIMUM LAPS OF 225MM. LAPS AT SPLICES TO BE 500MM MINIMUM UNLESS SPECIFIED OTHERWISE.

U.N.O STRUCTURAL AND REINFORCED BRICKWORK MUST BE CONSTRUCTED FROM BRICKS OF MINIMUM COMPRESSIVE STRENGTH 40 MPA, AND CONFORM TO THE REQUIREMENTS OF AS3700 SAA MASONRY CODE. ALL BED AND PROPEND JOINTS SHALL BE SOLIDLY FILLED WITH MORTAR, WITHOUT FURROWING, TO A MAXIMUM THICKNESS OF 10MM. JOINTS SHALL BE NOT LESS THAN 6MM. U.N.O. ALL MASONRY WALLS ARE TO BE TIED TO STRUCTURAL MEMBERS OR BUTTING WALLS, EVERY 2ND COURSE FOR BLOCKWORK, AND EVERY 4TH COURSE FOR BRICKWORK. HORIZONTAL SPACING SHALL BE 600MM MAXIMUM STAGGERED. ALL DEFINED CAVITIES SHALL BE KEPT FREE OF MORTAR AND OR DROPPINGS. EXPANSION JOINTS SHALL BE LOCATED 6000MM MAXIMUM CTRS AND 470MM FROM THE CORNERS, AT THE APPROXIMATE LOCATIONS SHOWN ON THE DRAWINGS.

FLOOD AFFECTED

CONSTRUCTION DRAWINGS






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A 30/01/2024 CONSTRUCTION DRAWINGS ISSUE 15/03/2024 ADJUSTMENTS AS PER REQUEST DATED 21/02/24 & 11/03/24


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PROPOSED N	EW HOUSE			SECTIONS		
53 MCCROSSI	N AVENUE, BIRF	RONG NSW 214	3			
FOR	MCKENZIE	DRAWN BY	BP	SCALE	DRAWING NO.	REV
PROJECT NO	23027	DESIGN	CUSTOM	As indicated @ A3	CD15	D




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53 MCCROSSIN AVENUE, BIRRONG NSW 2143 DRAWN BY **SCALE** DRAWING NO. REV **MCKENZIE** PROJECT NO 23027 **CD16** D DESIGN 1:10 @ A3 CUSTOM

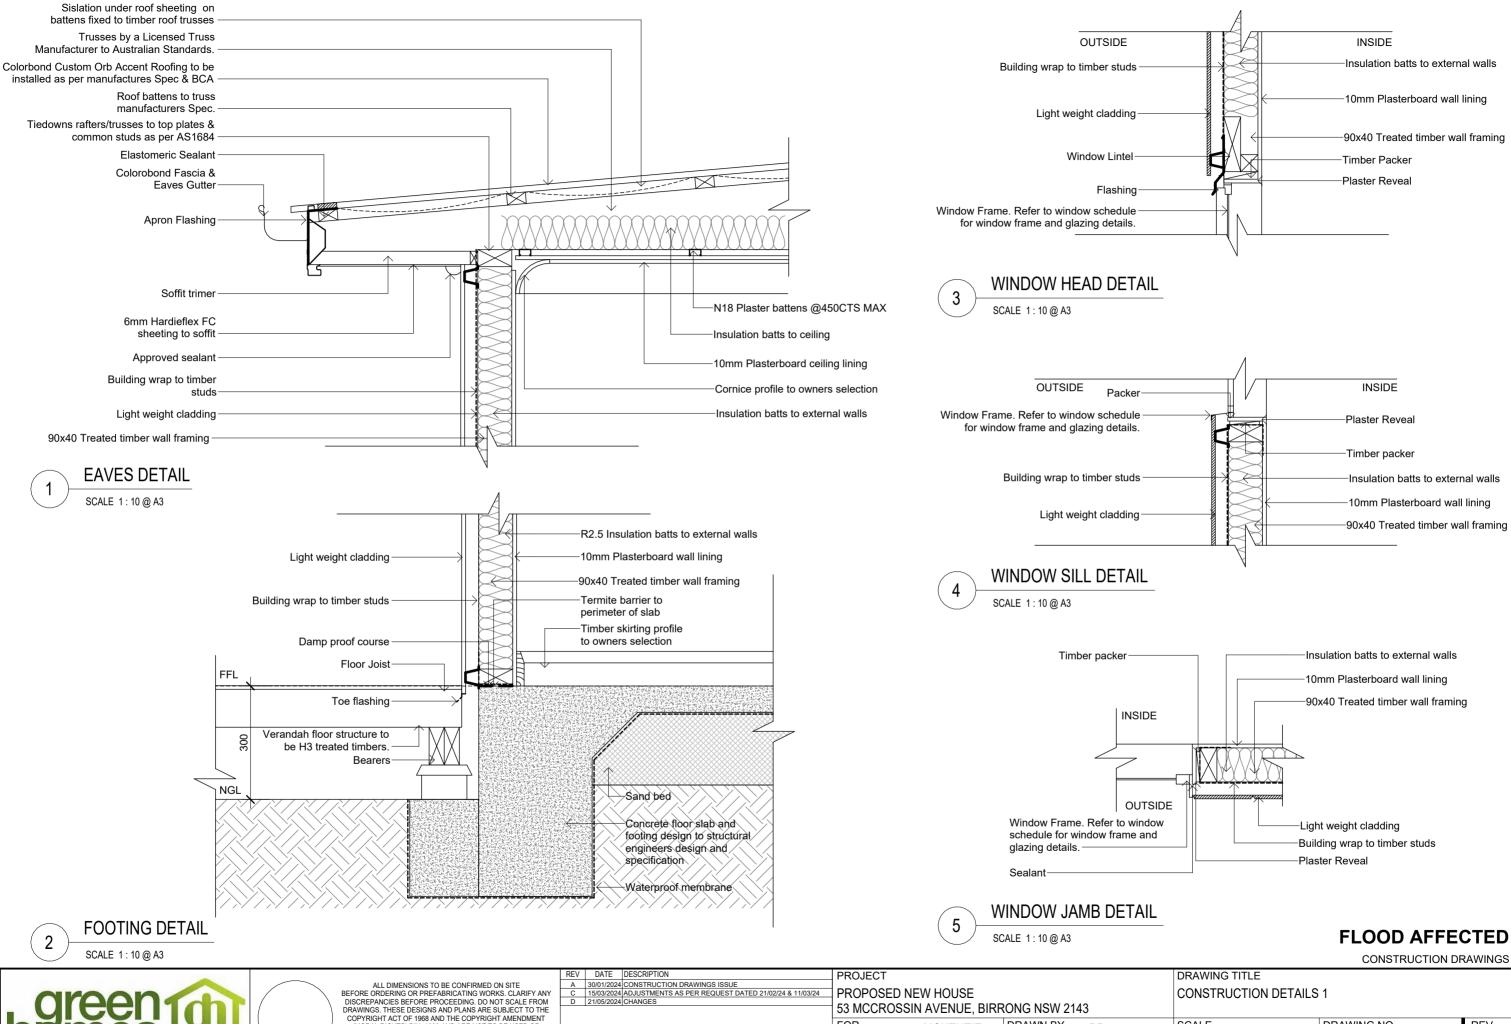

TYPICAL HOBLESS SHOWER DETAIL

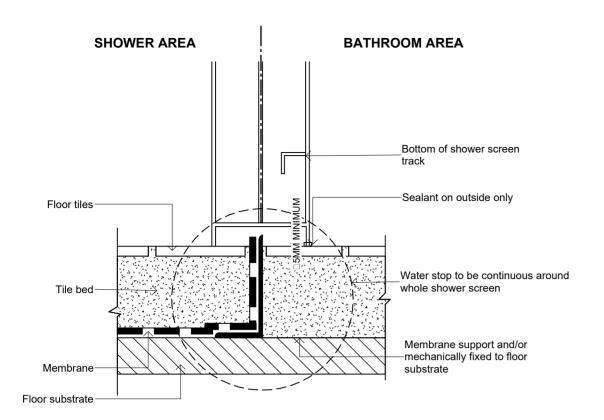SCALE 1:25 @ A3

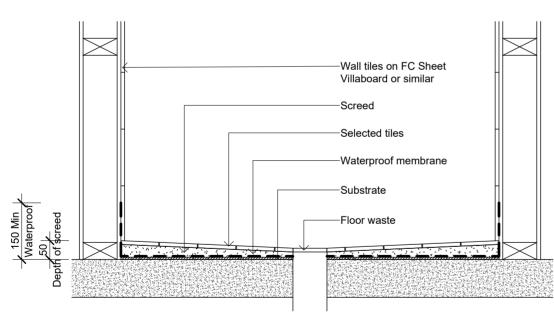

Note: Showerbase to be constructed as per AS 3740-2010

SHOWER BASE DETAIL SCALE 1:10 @ A3

2

BRICK VENEER - EXTERNAL DOOR HEAD DETAIL SCALE 1:5 @ A3

INSIDE

Timber Packer

-Door leaf

Rebated head jamb

Insulation batts to external walls

10mm Plasterboard wall lining

90x40 Treated timber wall framing

-Weatherstrip to permieter of door

OUTSIDE

Building wrap to


timber studs

Selected Brick

Window Lintel

Rebated side jambs

Flashing-

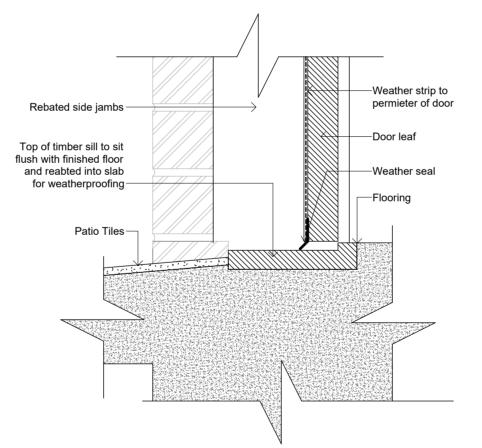

BRICK VENEER - EXTERNAL DOOR THRESHOLD DETAIL SCALE 1:5@A3

BRICK VENEER - EXTERNAL WALL AIRTIGHT DETAIL

Insulation batts to external walls

90x40 Treated timber wall framing

−Building wrap to timber studs to

Overlap should be 150mm

Insulation tape at joint

-Selected Brick

overlap at a stud where possible.


10mm Plasterboard wall lining

SCALE 1:5@A3

5

OUTSIDE

INSIDE

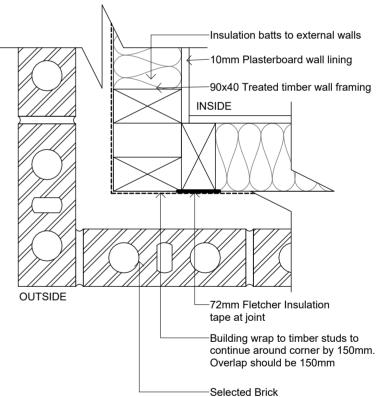

BRICK VENEER - EXT. CORNER WALL AIRTIGHT DETAIL

SCALE 1:5@A3


NOTE: Affix building wrap with glvanised


staples/metal fixings every 150mm. Top


6


**FLOOD AFFECTED** 

layer of building wrap to overlap with bottom layer of building wrap by 150mm. **CONSTRUCTION DRAWINGS** 

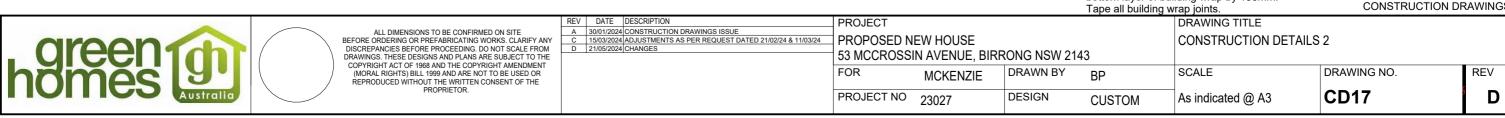


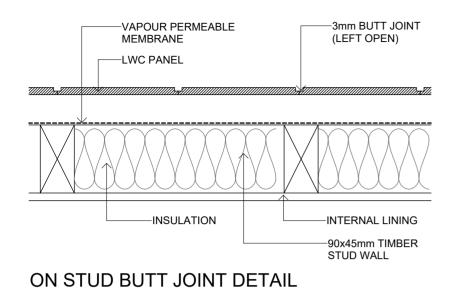


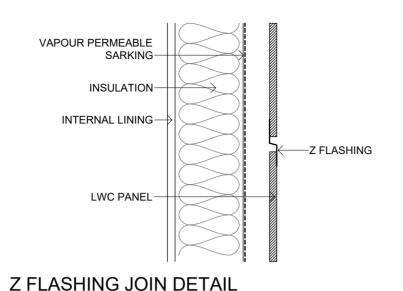

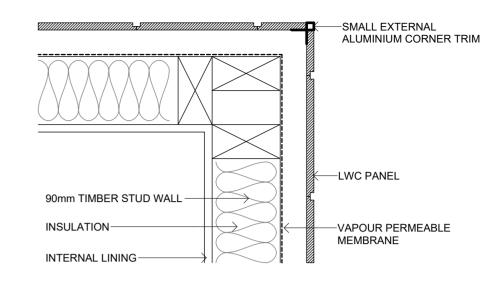

SMALL EXTERNAL "BOX" CORNER DETAIL

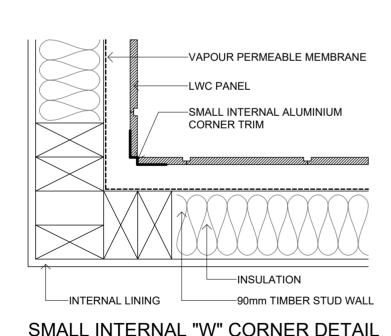

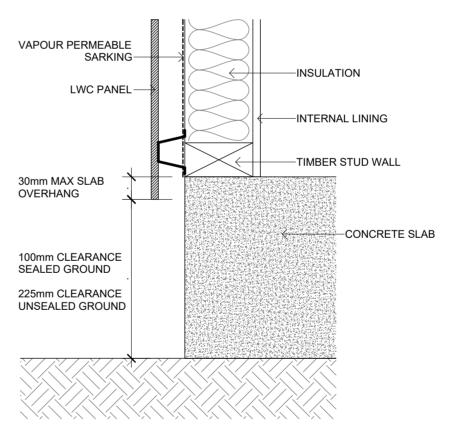

CONCRETE SLAB GROUND CLEARANCE DETAIL

PROJECT NO 23027

#### **FLOOD AFFECTED**

CONSTRUCTION DRAWINGS

REV

D





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PROJECT DRAWING TITLE
PROPOSED NEW HOUSE
53 MCCROSSIN AVENUE, BIRRONG NSW 2143
FOR MCKENZIE DRAWN BY BP SCALE

DESIGN

CUSTOM

DRAWING TITLE
LIGHTWEIGHT CLADDING CONSTRUCTION DETAILS

DRAWING NO.

**CD18** 

1:5@A3

WINDOW SCHEDULE								
NUMBER	WINDOW STYLE	HEIGHT	WIDTH	FRAMING MATERIAL	GLAZING	NOTES		
W01	Fixed	2100	500	Aluminium	Double Glazed			
W02	Awning	2040	800	Aluminium	Double Glazed			
W03	Awning	1800	2000	Aluminium	Double Glazed			
N04	Awning	1800	2000	Aluminium	Double Glazed			
W05	Awning	1800	2000	Aluminium	Double Glazed			
W06	Awning	1800	2000	Aluminium	Double Glazed			
N07	Awning	1000	1500	Aluminium	Double Glazed			
80W	Awning	1000	1500	Aluminium	Double Glazed			
N09	Awning	1000	600	Aluminium	Double Glazed			
W10	Awning	500	1000	Aluminium	Double Glazed			
W11	Awning	1000	600	Aluminium	Double Glazed			
N12	Awning	1000	1500	Aluminium	Double Glazed			
W13	Awning	1000	1500	Aluminium	Double Glazed			
W14	Awning	1000	600	Aluminium	Double Glazed			
W15	Awning	500	1500	Aluminium	Double Glazed	Automated		
W16	Awning	500	1500	Aluminium	Double Glazed	Automated		
N17	Awning	500	1500	Aluminium	Double Glazed	Automated		
W18	Awning	500	1500	Aluminium	Double Glazed	Automated		
W19	Fixed	700	1500	Aluminium	Double Glazed			
W20	Fixed	500	2000	Aluminium	Double Glazed			
W21	Skylight	720	568	Aluminium	Double Glazed			
N32	Awning	1200	1500	Aluminium	Double Glazed			
N33	Awning	500	1000	Aluminium	Double Glazed			
W34	Awning	1200	1500	Aluminium	Double Glazed			
N35	Awning	2040	2000	Aluminium	Double Glazed			
W36	Awning	500	1000	Aluminium	Double Glazed			

DOOR SCHEDULE							
NUMBER	HEIGHT	WIDTH	FINISH	FRAME MATERIAL	COMMENTS		
D01	2040	920	Paint	Timber	Solid Core, Flush Panel, Hinged Door		
D02	2100	5000	Powdercoat	Aluminium	Garage Sectional Door		
D03	2040	870	Paint	Timber	Solid Core, Flush Panel, Hinged Door		
D04	2040	870	Paint	Timber	Solid Core, Flush Panel, Caivty Slider		
D05	2040	870	Paint	Timber	Solid Core, Flush Panel, Hinged Door		
D06	2068	1056	Paint	Timber	Solid Core, Double Barn Door		
D07	2040	870	Paint	Timber	Solid Core, Flush Panel, Hinged Door		
D08	2040	870	Paint	Timber	Solid Core, Flush Panel, Hinged Door		
D09	2100	2000	Powdercoat	Aluminium	Cavity Sliding Glazed Door		
D10	2040	870	Paint	Timber	Solid Core, Flush Panel, Caivty Slider		
D11	2040	820	Paint	Timber	Solid Core, Flush Panel, Caivty Slider		
D12	2040	980	Paint	Aluminium	Robe Slider		
D13	2100	2000	Powdercoat	Aluminium	Glazed Sliding Door		
D14	2040	2180	Powdercoat	Aluminium	Robe Slider		
D15	2040	870	Paint	Timber	Solid Core, Flush Panel, Hinged Door		
D16	2040	2180	Powdercoat	Aluminium	Robe Slider		
D17	2040	870	Paint	Timber	Solid Core, Flush Panel, Hinged Door		
D18	2040	820	Paint	Timber	Solid Core, Flush Panel, Hinged Door		
D35	2040	820	Paint	Timber	Solid Core, Flush Panel, Hinged Door		
D36	2040	820	Paint	Timber	Solid Core, Flush Panel, Hinged Door		
D38	2040	820	Paint	Timber	Solid Core, Flush Panel, Hinged Door		
D39	2040	820	Paint	Timber	Solid Core, Flush Panel, Hinged Door		
D41	2100	1800	Powdercoat	Aluminium	Glazed Sliding Door		
D42	2060	940	Paint	Timber	Bi Fold Door		
D43	2040	1780	Powdercoat	Aluminium	Robe Slider		
D44	2040	1780	Powdercoat	Aluminium	Robe Slider		

#### WINDOWS, GLAZED DOORS AND SKYLIGHTS:

THE APPLICANT MUST INSTALL ALL WINDOWS, GLAZED DOORS AND SHADING DESCRIBED IN THE TABLE, IN ACCORDANCE WITH THE SPECIFICATIONS LISTED IN THE TABLE. RELEVANT OVERSHADOWING SPECIFICATIONS MUST BE FOR EACH WINDOW AND GLAZED DOOR.

THE DWELLING MAY HAVE 1 SKYLIGHT (LESS THAN 0.7 SQUARE METERS) AND UP TO 2 WINDOWS/GLAZED DOORS (LESS THAN 0.7 SQUARE METERS) WHICH ARE NOT LISTED IN THE TABLE.

THE FOLLOWING REQUIREMENTS MUST ALSO BE SATISFIED IN RELATION TO EACH WINDOW AND GLAZED DOOR:

EXCEPT WHERE THE GLASS IS "SINGLE CLEAR" OR "SINGLE TONED" THE U-VALUE AND SHGC FOR ALL WINDOWS AND GLAZED DOORS MUST BE CALCULATED IN ACCORDANCE WITH AUSTRALIAN NATIONAL AVERAGE CONDITIONS

THE LEADING EDGE OF EACH EAVES, PERGOLA, VERANDAH BALCONY OR AWNING MUST BE NO MORE THAN 500 MILLIMETERS ABOVE THE HEAD OF THE WINDOW OR GLAZED DOOR, EXCEPT THAT A PROJECTION GREATER THAN 500MM AND UP TO 1500MM ABOVE THE HEAD MUST BE TWICE THE VALUE.


PERGOLAS WITH POLYCARBONATE ROOF OR SIMILAR TRANSLUCENT MATERIAL MUST HAVE A SHADING COEFFICIENT OF LESS THAN 0.35. PERGOLAS WITH FIXED BATTENS MUST HAVE BATTENS PARALLEL TO THE WINDOW OR GLAZED DOOR ABOVE WHICH THEY ARE SITUATED, UNLESS THE PERGOLA ALSO SHADES A PERPENDICULAR WINDOW. THE SPACING BETWEEN BATTENS MUST NOT BE MORE THAN 50MM.

#### LEGEND

DESIGNED IN ACCORDANCE WITH BCA

- FLASHING TO WALL OPENINGS 3.5.3.6
- GLAZING & WINDOW ASSEMBLIES 3.6.0

BUILDER TO CONFIRM SIZES ON SITE BEFORE ORDERING

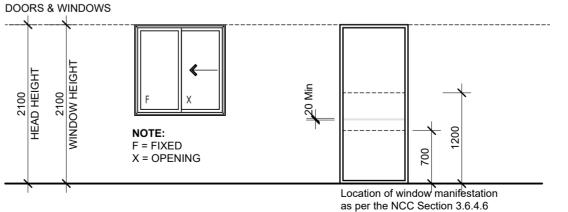

#### **FLOOD AFFECTED**

CONSTRUCTION DRAWINGS







ALL DIMENSIONS TO BE CONFIRMED ON SITE BEFORE ORDERING OR PREFABRICATING WORKS. CLARIFY ANY DISCREPANCIES BEFORE PROCEEDING. DO NOT SCALE FROM DRAWINGS. THESE DESIGNS AND PLANS ARE SUBJECT TO THE COPYRIGHT ACT OF 1968 AND THE COPYRIGHT AMENDMENT (MORAL RIGHTS) BILL 1999 AND ARE NOT TO BE USED OR REPRODUCED WITHOUT THE WRITTEN CONSENT OF THE PROPRIETOR.

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PROJECT				DRAWING TITLE		
PROPOSED N	EW HOUSE			WINDOW AND DOOR SCHEDULE		
53 MCCROSSI	N AVENUE, BIRF	RONG NSW 214	3			
FOR	MCKENZIE	DRAWN BY	BP	SCALE	DRAWING NO.	REV
PROJECT NO	00007	DESIGN	OLIOTOM	1 1:50 @ A3	CD19	ח
T ROOLOT NO	23027	DEGIGIA	CUSTOM	1 . 30 @ A3	CD19	ם

GRANNY FLAT	AREA
Living	59 m²
Porch	4 m²
Grand total	64 m²



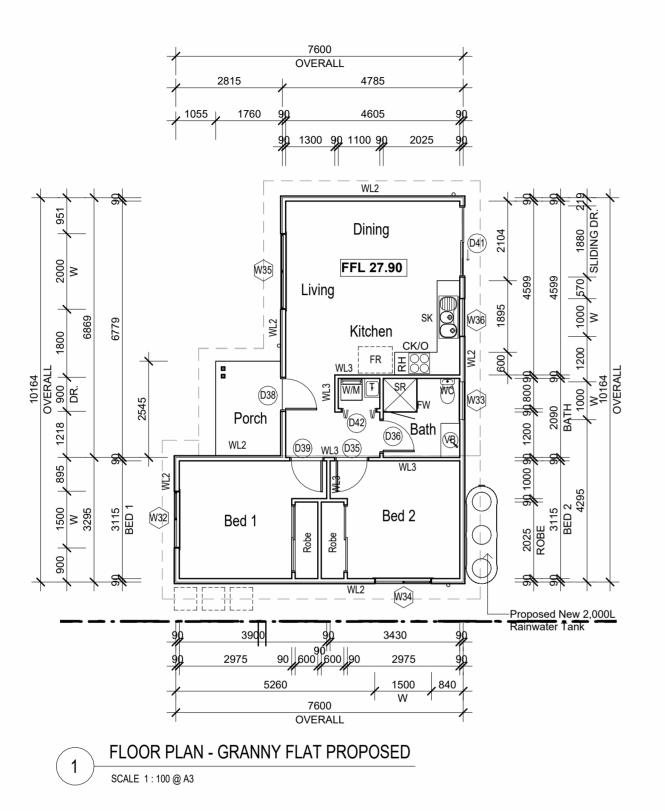

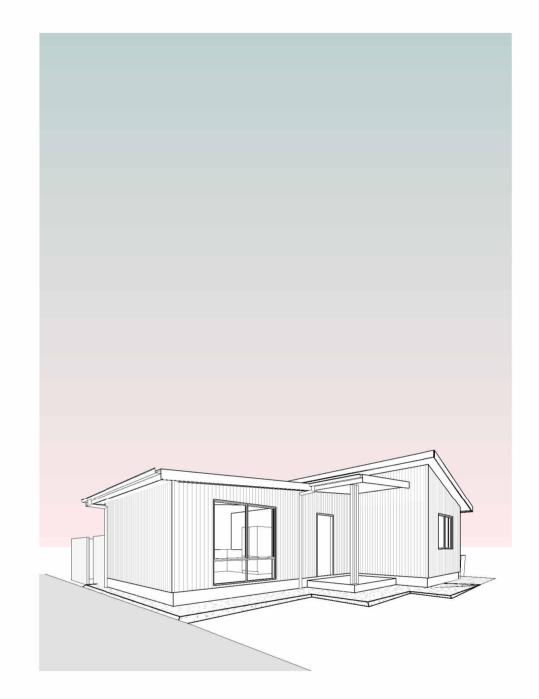6 3D View - Granny Flat

# **FLOOD AFFECTED**

CONSTRUCTION DRAWINGS





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PROJECT
PROPOSED NEW HOUSE
53 MCCROSSIN AVENUE, BIRRONG NSW 2143


FOR MCKENZIE DRAWN BY BP
PROJECT NO 23027 DESIGN CUSTOM 1: 100 @ A3

CD20

DRAWING TITLE
GRANNY FLAT - PROPOSED


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MAX. HEIGHT LINE 9.0m

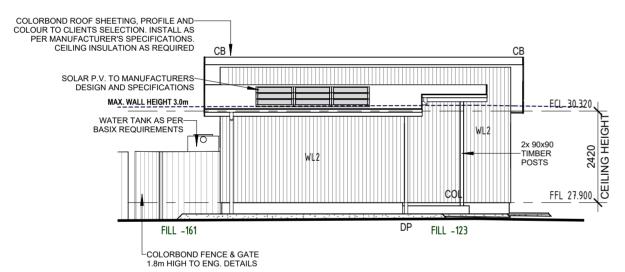

NORTH ELEVATION - GRANNY FLAT PROPOSED

SCALE 1:100 @ A3



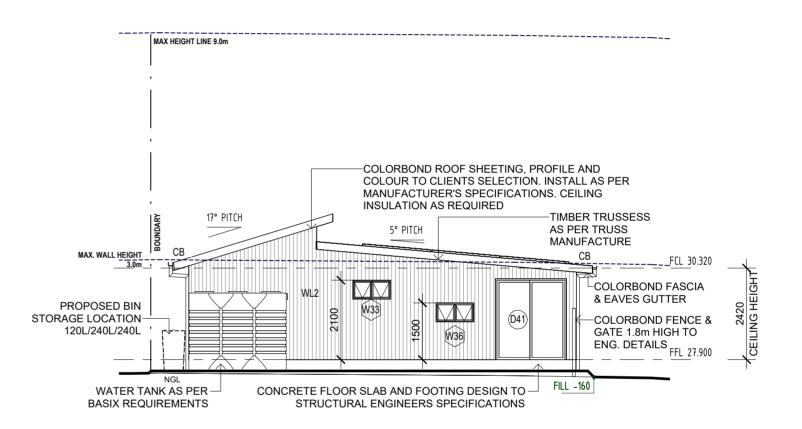

DESIGN

#### FLOOD AFFECTED

CONSTRUCTION DRAWINGS





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OJECT
OPOSED NEW HOUSE
MCCROSSIN AVENUE, BIRRONG NSW 2143


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CUSTOM

1:100 @ A3

CD21

D

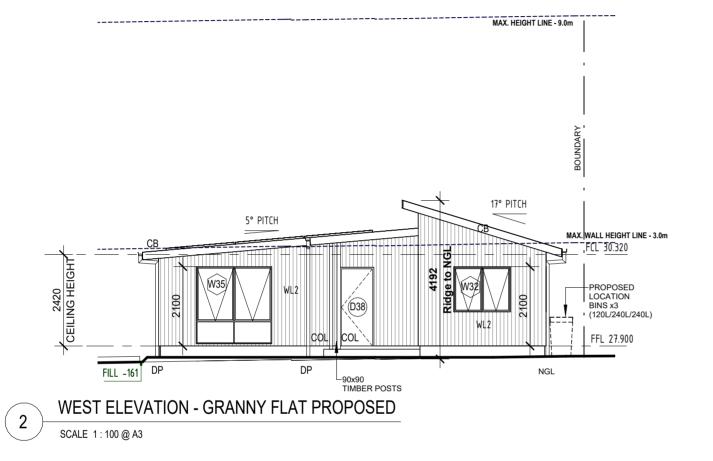

MAX. WALL HEIGHT 3.0m

PROPOSED

PROPOSED

JOCATION

NGL

PROPOSED

JOCATION

PROPOSED

SOUTH ELEVATION - GRANNY FLAT PROPOSED

SCALE 1:100@A3

MAX. HEIGHT LINE 9.0m

# FLOOD AFFECTED

CONSTRUCTION DRAWINGS





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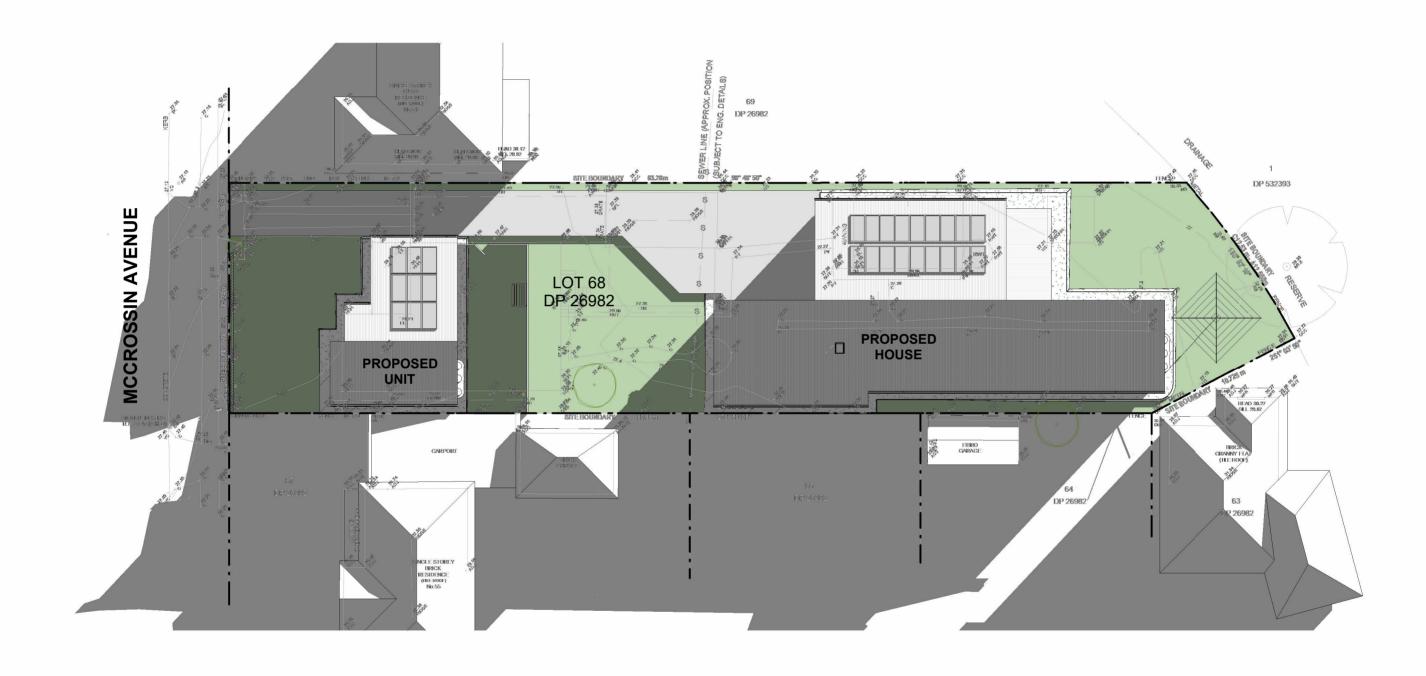
 PROPOSED NEW HOUSE
 GRANNY FLAT - PROPOSED ELEVATIONS 2

 53 MCCROSSIN AVENUE, BIRRONG NSW 2143
 SCALE

 FOR
 MCKENZIE
 DRAWING NO.

 PROJECT NO
 23027
 DESIGN
 CUSTOM

 1 : 100 @ A3
 CD22





# **FLOOD AFFECTED**

CONSTRUCTION DRAWINGS

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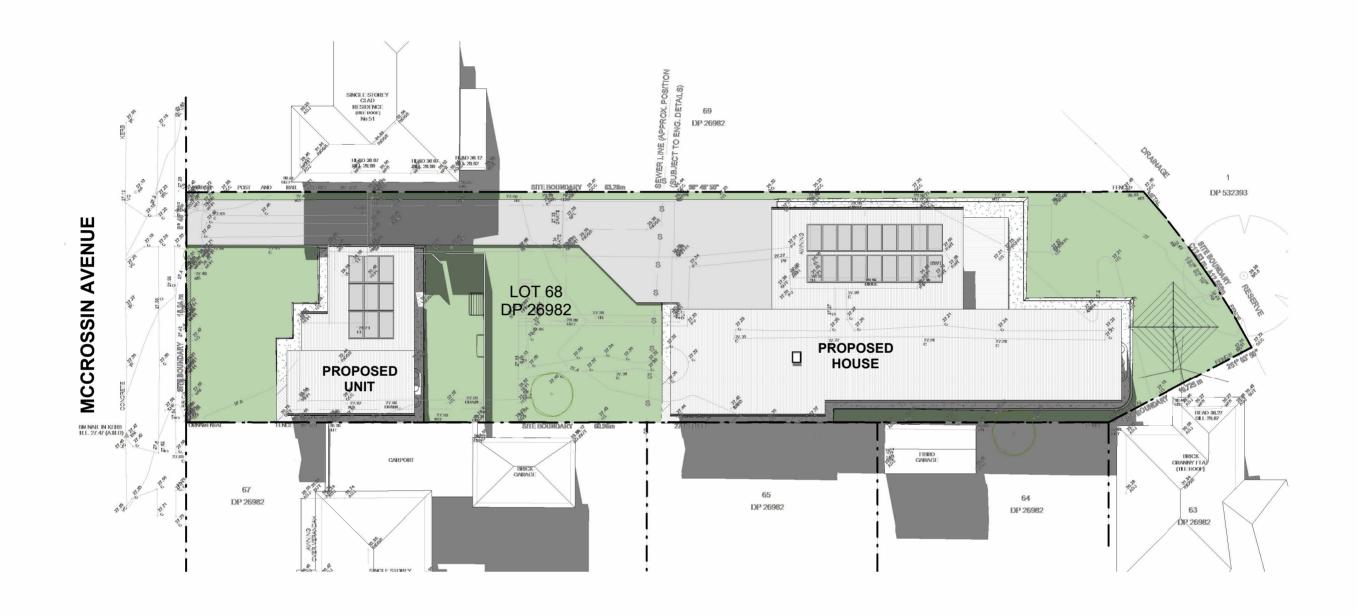
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PROJECT
PROPOSED NEW HOUSE
53 MCCROSSIN AVENUE, BIRRONG NSW 2143

DRAWING TITLE
SHADOW DIAGRAM - WINTER 21ST OF JUNE 8AM

 FOR
 MCKENZIE
 DRAWN BY
 BP
 SCALE
 DRAWING NO.

 PROJECT NO
 23027
 DESIGN
 CUSTOM
 1 : 250 @ A3
 CD23



# WINTER 21st of JUNE 12pm SCALE 1: 250 @ A3

# **FLOOD AFFECTED**

CONSTRUCTION DRAWINGS

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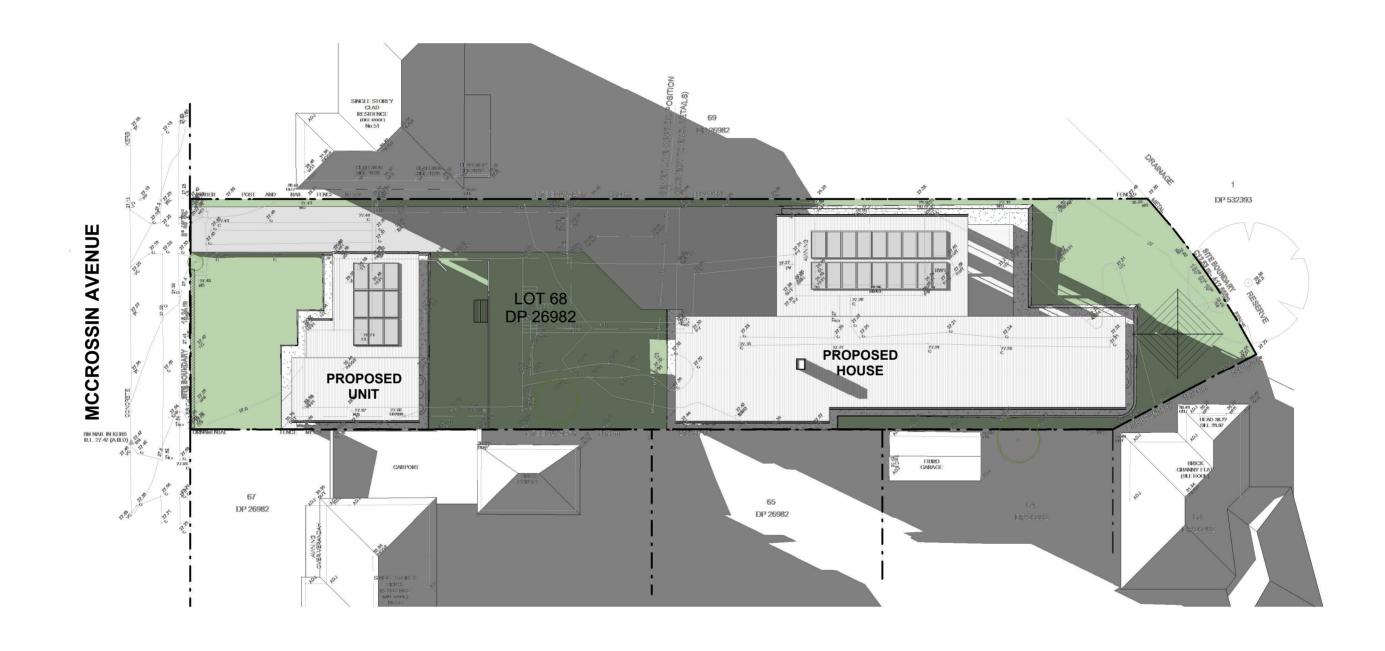
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PROJECT DRAWING TITLE
PROPOSED NEW HOUSE SHADOW DIAGRAM - WINTER 21ST OF JUNE 12PM
53 MCCROSSIN AVENUE, BIRRONG NSW 2143
FOR MCKENZIE DRAWN BY BP SCALE DRAWING NO. REV

FOR MCKENZIE DRAWN BY BP SCALE
PROJECT NO 23027 DESIGN CUSTOM 1: 250 @ A3

CD24



# 1 WINTER 21st of JUNE 4pm SCALE 1: 250 @ A3

# **FLOOD AFFECTED**

**CD25** 

CONSTRUCTION DRAWINGS

REV

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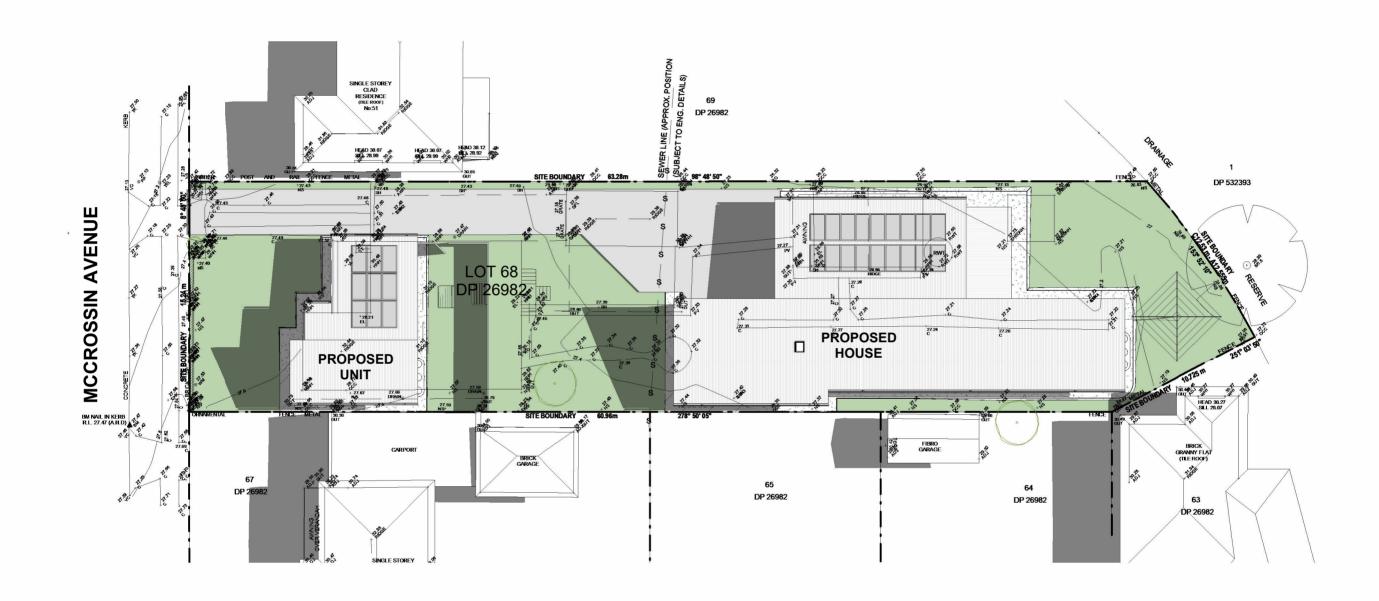
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				PROJECT NO	23027

PROJECT
PROPOSED NEW HOUSE
53 MCCROSSIN AVENUE, BIRRONG NSW 2143
FOR MCKENZIE DRAWN BY BP SCALE DRAWING NO.

CUSTOM

1 : 250 @ A3

DESIGN





# SUMMER 21st of DECEMBER 8am

SCALE 1: 250 @ A3

# **FLOOD AFFECTED**

CONSTRUCTION DRAWINGS

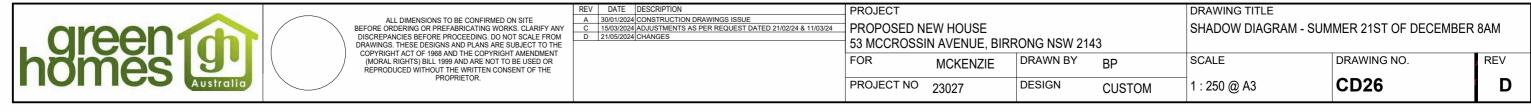

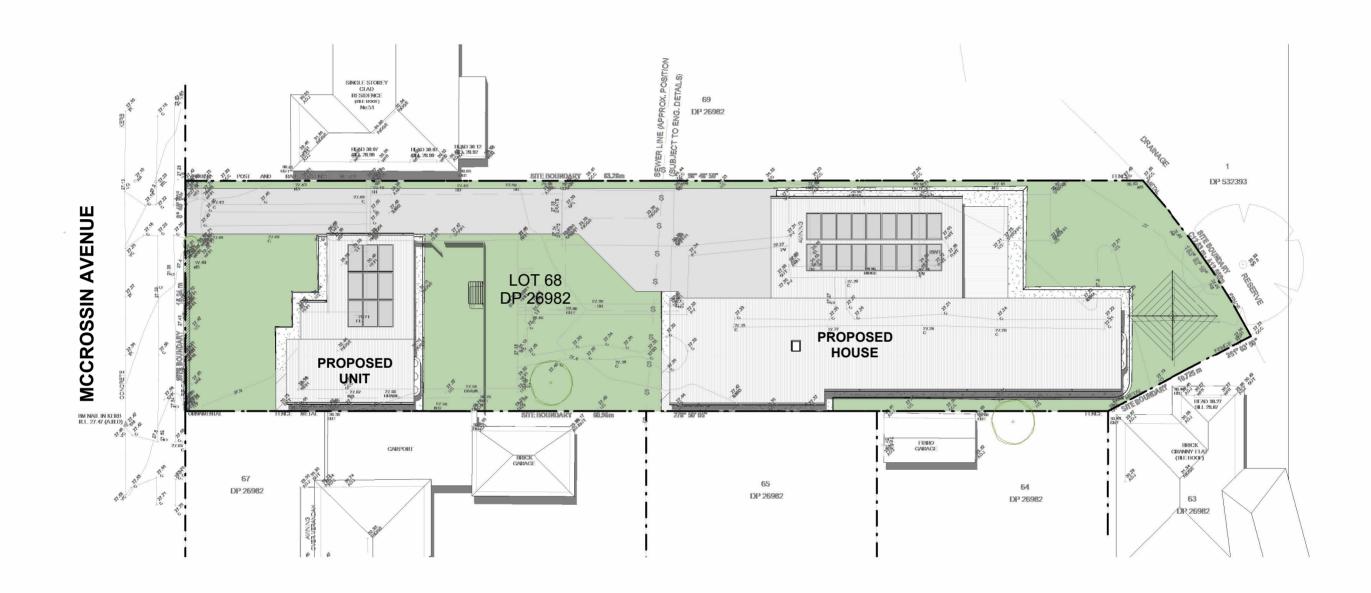

# 1


# SUMMER 21st of DECEMBER 12pm

SCALE 1 : 250 @ A3

CONSTRUCTION DRAWINGS

FLOOD AFFECTED

. green	ALL DIMENSIONS TO BE CONFIRMED ON SITE BEFORE ORDERING OR PREFABRICATING WORKS. CLARIFY ANY DISCREPANCIES BEFORE PROCEEDING. DO NOT SCALE FROM DRAWINGS. THESE DESIGNS AND PLANS ARE SUBJECT TO THE	PROJECT PROPOSED N 53 MCCROSS	NEW HOUSE SIN AVENUE, BIRF	RONG NSW 21	43	DRAWING TITLE SHADOW DIAGRAM - SUN	MMER 21ST OF DECEMBER	12PM
homes Australia	COPYRIGHT ACT OF 1968 AND THE COPYRIGHT AMENDMENT (MORAL RIGHTS) BILL 1999 AND ARE NOT TO BE USED OR REPRODUCED WITHOUT THE WRITTEN CONSENT OF THE PROPRIETOR.	FOR PROJECT NO	MCKENZIE 23027	DRAWN BY DESIGN	BP CUSTOM	1: 250 @ A3	CD27	REV <b>D</b>

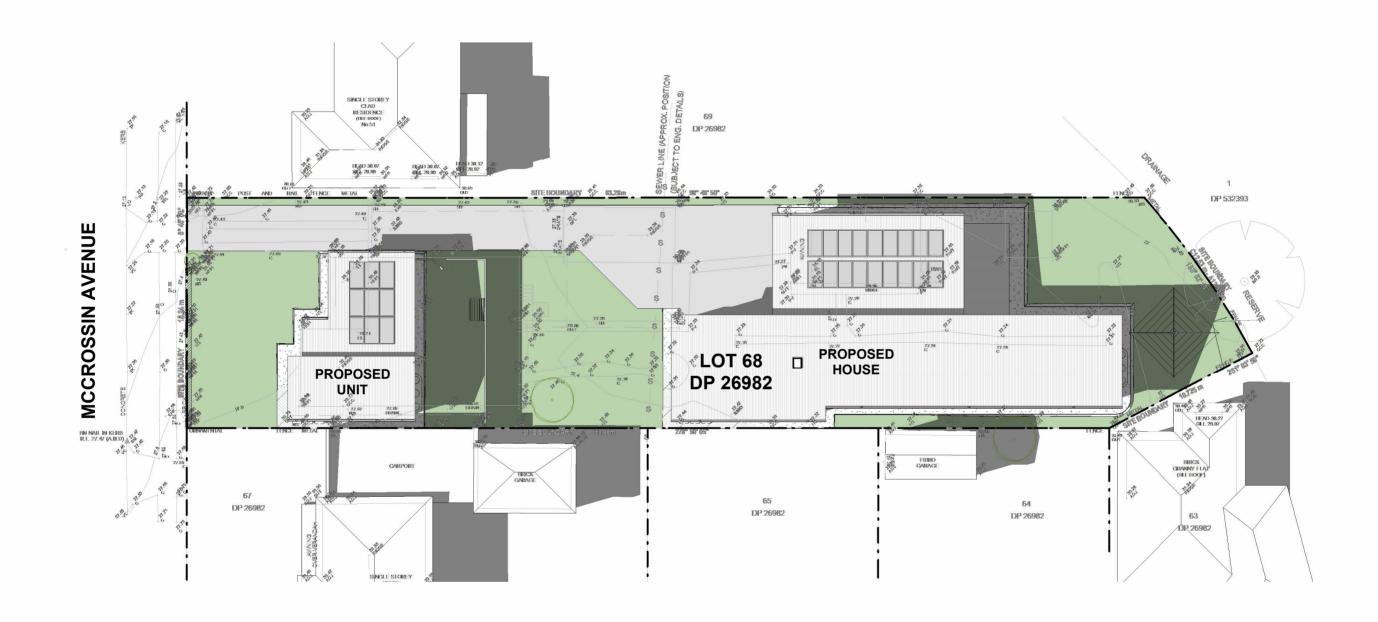

# SUMMER 21st of DECEMBER 4pm

SCALE 1: 250 @ A3

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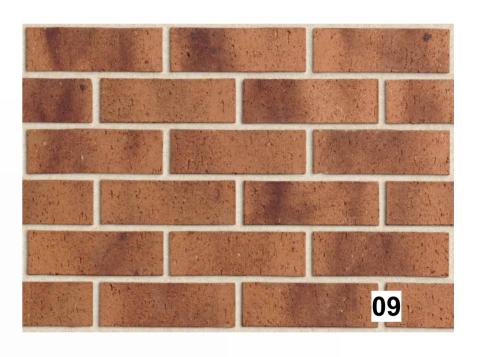
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	FLOOD AFFECTED
	CONSTRUCTION DRAWINGS
	DRAWING TITLE
EW HOUSE	SHADOW DIACDAM SHIMMED 21ST OF DECEMBED 4DM

PROPOSED NEW HOUSE 53 MCCROSSIN AVENUE, BIRRONG NSW 2143				SHADOW DIAGRAM - SUMMER 21ST OF DECEMBER 4PM		
FOR	MCKENZIE	DRAWN BY	BP	SCALE	DRAWING NO.	REV
PROJECT NO	23027	DESIGN	CUSTOM	1:250 @ A3	CD28	D

# **COLOUR AND FINISHES SCHEDULE**

No.	Location	Product	Colour and Finish
01	Roof	Custom Orb Colorbond	Surfmist
02	Gutter	Colorbond Quad Gutter	Surfmist
03	Fascia	Colorbond Fascia	White
04	Downpipe	PVC Round	Surfmist
05	Window Frame	Aluminium	White
06	Wall - Cladding	Axon Vertical Cladding	Surfmist
07	Garage Door	Colorbond Slimline	White
08	Column	Timber	White
09	Wall - Bricks	PGH	Red Gum



03, 05, 07 & 08

01, 02, 04 & 06

## **FLOOD AFFECTED**

CONSTRUCTION DRAWINGS





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				FOR	MCKE
				PROJECT NO	23027

OPOSED NEW HOUSE
MCCROSSIN AVENUE, BIRRONG NSW 2143

R MCKENZIE DRAWN BY E

DRAWING TITLE
COLOUR AND FINISHES SCHEDULE

DRAWING NO.

**CD29** 

DRAWN BY BP SCALE
DESIGN CUSTOM 1:50 @ A3

REV **D** 



# **FLOOD AFFECTED**

CONSTRUCTION DRAWINGS





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PROPOSED NEW HOUSE
53 MCCROSSIN AVENUE, BIRRONG NSW 2143
FOR MCKENZIE DRAWN BY

DRAWING TITLE FRONT STREETSCAPE - No.53

SCALE

1:100@A3

FOR MCKENZIE DRAWN BY BP
PROJECT NO 23027 DESIGN CUSTOM

CD30

D

REV

